VARIOUS PARK SITES PLAYGROUND AND WALKWAY IMPROVEMENT PROJECT

GENERAL NOTES

- ALL WORK SHALL CONFORM TO THE GREENBOOK, 'STANDARD SPECIFICATIONS AND PLANS FOR PUBLIC WORKS CONSTRUCTION' IN EFFECT AS OF THE DATE OF THESE PLANS.
- 2. CONSTRUCTION PERMITS SHALL BE PAID FOR BY THE DISTRICT.
- 3. PLAY EQUIPMENT TO BE INSTALLED AND INSPECTED BY CERTIFIED PLAYGROUND INSTALLER: INSTALLER TO PROVIDE DISTRICT OF EQUIPMENTS CONFORMANCE TO PLAYGROUND SAFETY STANDARDS IN FORCE DURING PROJECT INSTALLATION.
- UPON CONTRACT EXECUTION, CONTRACTOR TO PROVIDE DISTRICT WITH A CRITICAL PATH SCHEDULE TO INCLUDE EACH ITEM, LEAD TIME, ORDER AND INSTALLATION DATE FOR SUBSTANTIAL COMPLETION.
- 5. PROVIDE FOR POSITIVE DRAINAGE. NOTIFY DISTRICT CONTACT IF SITE CONDITIONS ARE OTHERWISE. MAINTAIN EXISTING FLOWLINES AND DRAINAGE PATTERNS.
- 6. VERIFY AND STAKE LOCATION OF UTILITIES PRIOR TO CONSTRUCTION AND AS REQUIRED BY GOVERNING AGENCIES. CONTRACTOR IS LIABLE FOR DAMAGES TO EXISTING UTILITIES INCURRED BY PROJECT WORK.
- 7. REPAIR AND REPLACE ANY EXISTING IMPROVEMENTS DAMAGED DURING CONSTRUCTION TO PRE-CONSTRUCTION CONDITION TO DISTRICT'S SATISFACTION.
- CHECK DIMENSIONS AND SITE CONDITIONS BEFORE STARTING WORK. ANY DISCREPANCIES OR POSSIBLE DEFICIENCIES BETWEEN DRAWINGS AND SPECIFICATIONS WITH FIELD CONDITIONS SHALL BE BROUGHT TO THE DISTRICT'S IMMEDIATE ATTENTION.
- VERIFY PROPERTY LINES PRIOR TO COMMENCING WORK. NO CONSTRUCTION ITEM, INCLUDING FOOTINGS, SHALL EXTEND BEYOND PROPERTY LINE.
- 10. MATERIALS AND WORKMANSHIP, CONFORM TO LATEST CALIFORNIA BUILDING CODES AND APPLICABLE GOVERNING AGENCY CODES AND ORDINANCES. NO PART OF CONTRACT DOCUMENTS TO BE IN VIOLATION OF CODES. IF DISCREPANCIES EXIST, NOTIFY DISTRICT.
- 11. CONSTRUCTION AND INSTALLATION OF ALL LANDSCAPE ITEMS SHALL BE ACCORDING TO STATE, COUNTY AND LOCAL CODES, ORDINANCES AND UP TO CAL-OSHA SAFETY ORDERS REGARDING PERFORMANCE OF WORK.
- 12. EXCAVATION IN THE VICINITY OF UNDERGROUND UTILITIES SHALL PROCEED WITH CARE AND, IF NECESSARY, BY HAND THE CONTRACTOR BEARS FULL RESPONSIBILITY FOR THIS WORK AND THE DISRUPTION OR DAMAGE TO UTILITIES SHALL BE IMMEDIATELY REPAIRED AT NO EXPENSE TO THE DISTRICT.

GENERAL NOTES II

- THE CONTRACTOR SHALL LAYOUT AND VERIFY ALL DIMENSIONS PRIOR TO ORDERING PLAY EQUIPMENT AND CONSTRUCTION. ANY DISCREPANCIES SHALL BE BROUGHT TO THE DISTRICT'S ATTENTION FOR RESOLUTION
- CONTRACTOR SHALL BE RESPONSIBLE FOR ANY COORDINATION WITH SUB-CONTRACTORS REQUIRED TO ACCOMPLISH THE WORK.
- PIPING, FOOTINGS, AND SLEEVES SHALL BE SET IN PRIOR TO INSTALLATION OF CONSTRUCTION ITEMS.
- THE DRAWINGS AND SPECIFICATIONS REPRESENT FINISH STRUCTURES. CONSTRUCTION MEANS AND METHODS, SAFETY PROCEDURES, BRACING, TEMPORARY SUPPORTS, AND SHORING WILL BE THE SOLE RESPONSIBILITY OF THE CONTRACTOR. OBSERVATION VISITS TO THE JOB SITE BY THE DISTRICT CONTACT DOES NOT INCLUDE INSPECTION OF CONSTRUCTION METHODS AND SAFETY CONDITIONS AT WORK SITE. THESE VISITS SHALL NOT BE CONSTRUED AS CONTINUOUS AND DETAILED INSPECTIONS.
- GIVE DISTRICT CONTACT A MINIMUM OF 48 HOURS NOTICE FOR REQUIRED OR REQUESTED JOB SITE VISIT.
- FOR SUBMITTALS, SAMPLES AND SHOP DRAWINGS REQUESTED, SUBMIT VIA EMAIL TO DISTRICT CONTACT.
- PROPOSED GRADES SHALL MEET EXISTING GRADES WITH SMOOTH AND CONTINUOUS TRANSITION, FLUSH ALONG ENTIRE EDGE.

GRADING NOTES

- PRIOR TO CONSTRUCTION, VERIFY EXISTING AND PROPOSED GRADES, UTILITY LOCATIONS, EXISTING DRAINAGE STRUCTURES,
- NOTIFY THE DISTRICT CONTACT IMMEDIATELY UPON DISCREPANCIES BETWEEN THESE PLANS AND EXISTING CONDITIONS.
- GRADE PLANTING AREAS ACCORDING TO CONSTRUCTION PLAN AWAY FROM HARDSCAPE AND PROPERTY LINES.
- FINISH GRADES IN PLANTING AREAS TO BE FLUSH WITH ADJACENT PAVING
- DO NOT PROCEED WITH CONSTRUCTION AS DESIGNED WHEN OBSTRUCTIONS, AREA DISCREPANCIES, OR GRADE DESIGN ARE DISCOVERED. SUCH CONDITION SHALL BE IMMEDIATELY BROUGHT TO THE DISTRICT CONTACT'S ATTENTION. CONTRACTOR ASSUMES FULL RESPONSIBILITY FOR NECESSARY REVISIONS DUE TO FAILURE TO GIVE SUCH NOTIFICATION.

STORM WATER POLLUTION NOTES

- ERODED SEDIMENTS AND OTHER POLLUTANTS MUST BE RETAINED ON SITE AND MAY NOT BE COURSES. OR WIND.
- 2. STOCKPILES OF EARTH AND OTHER CONSTRUCTION-RELATED MATERIALS MUST B
- 3. FUELS, OILS, SOLVENTS, AND OTHER TOXIC MATERIALS MUST BE STORED IN ACCORDANCE APPROVED STORAGE CONTAINERS ARE TO BE PROTECTED FROM THE WEATHER. SPILLS MUST BE CLEANED UP IMMEDIATELY AND DISPOSED OF IN A PROPER MANNER. SPILLS MAY NOT BE WASHED INTO THE DRAINAGE SYSTEM.
- 4. EXCESS OR WASTE CONCRETE MAY NOT BE WASHED INTO THE PUBLIC WAY OR ANY OTHER DRAINAGE SYSTEM. PROVISIONS SHALL BE MADE TO RETAIN CONCRETE WASTES ON SITE UNTIL THEY CAN BE DISPOSED OF AS SOLID WASTE.
- 5. TRASH AND CONSTRUCTION-RELATED SOLID WASTES MUST BE DEPOSITED INTO A COVERED RECEPTACLE TO PREVENT CONTAMINATION OF RAINWATER AND DISPERSAL BY WIND.
- 6. SEDIMENTS AND OTHER MATERIALS MAY NOT BE TRACKED FROM THE SITE BY VEHICLE TRAFFIC. THE CONSTRUCTION ENTRANCE ROADWAYS MUST BE STABILIZED SO AS TO INHIBIT SEDIMENTS FROM BEING DEPOSITED INTO THE PUBLIC WAY. ACCIDENTAL DEPOSITION MUST BE SWEPT UP IMMEDIATELY AND MAY NOT BE WASHED DOWN BY RAIN OR OTHER MEANS.
- 7. ANY SLOPES WITH DISTURBED SOILS OR DENUDED VEGETATION MUST BE STABILIZED SO AS TO INHIBIT EROSION BY WIND AND WATER.
- 8. THE FOLLOWING BMPS AS OUTLINED IN, BUT NOT LIMITED TO, THE CALIFORNIA STORMWATER BEST MANAGEMENT PRACTICE HANDBOOK, CALIFORNIA STORMWATER QUALITY ASSOCIATION (CASQA), 2003, OR THE LATEST REVISED EDITION, MAY APPLY DURING THE CONSTRUCTION OF THIS PROJECT (ADDITIONAL MEASURES MAY BE REQUIRED IF DEEMED APPROPRIATE BY CITY

ECO1 - SCHEDULING NS01 - WATER CONSERVATION PRACTICES

- NS03 PAVING AND GRINDING OPERATIONS
- NS06 ILLICIT CONNECTION/DISCHARGE NS08 - VEHICLE AND EQUIPMENT CLEANING
- NS09 VEHICLE AND EQUIPMENT FUELING NS10 - VEHICLE AND EQUIPMENT MAINTENANCE
- NS12 CONCRETE CURING
- **NS13 CONCRETE FINISHING** SE-6 - GRAVEL SANDBAGS

- SE07 STREET SWEEPING AND VACUUMING WE01 - WIND EROSION CONTROL WM01 - MATERIAL DELIVERY AND STORAGE
- WM02 MATERIAL USE WM03 - STOCKPILE MANAGEMENT
- WM04 SPILL PREVENTION AND CONTROL
- WM05 SOLID WASTE MANAGEMENT WM06 - HAZARDOUS WASTE MANAGEMENT
- WM08 CONCRETE WASTE MANAGEMENT

PROJECT DESCRIPTION

PROJECT IS WITHIN EXISTING PARK AND INCLUDES REMOVAL OF PLAY EQUIPMENT, RUBBER SURFACING AND SAND. INSTALLATION OF PLAYGROUND EQUIPMENT, ENGINEERED WOOD FIBER (EWF), PERMEABLE ASPHALT AND CONCRETE PAVING. FEES FOR PERMITS TO BE PAID BY THE DISTRICT. CONTRACTOR RESPONSIBLE FOR PROCESSING AND COORDINATING PERMITS WITH THE CITY OF THOUSAND OAKS.

SHEET INDEX

- L-1 COVER SHEET
- L-2 DOS VIENTOS NEIGHBORHOOD PARK **DEMOLITION PLAN**
- L-3 DOS VIENTOS NEIGHBORHOOD PARK CONSTRUCTION PLAN
- L-4 KIMBER NEIGHBORHOOD PARK **DEMOLITION PLAN**
- L-5 KIMBER NEIGHBORHOOD PARK CONSTRUCTION PLAN
- L-6 RANCHO CONEJO PLAYFIELD **DEMOLITION PLAN**
- L-7 RANCHO CONEJO PLAYFIELD CONSTRUCTION PLAN
- L-8 CONSTRUCTION DETAILS
- L-9 NORTH RANCH NEIGHBORHOOD PARK CONSTRUCTION PLAN AND DETAILS

UTILITIES

(CONTRACTOR SHALL CALL DIG ALERT AND NOTIFY ANY AGENCIES OR UTILITIES **48 HOURS PRIOR TO STARTING** CONSTRUCTION OR EXCAVATION. LIST BELOW FOR REFERENCE ONLY, CONTRACTOR IS RESPONSIBLE FOR VERIFYING LOCATIONS AND PROTECTING ALL UTILITIES.)

SOUTHERN CALIFORNIA EDISON 3589 FOOTHILL DRIVE THOUSAND OAKS, CALIFORNIA (800)655-4555

SO.CAL. GAS COMPANY 130 PATTERSON, SANTA BARBARA, CALIFORNIA HANK MORALES (800)427-2200

WATER AND WASTEWATER CITY OF THOUSAND OAKS 2100 THOUSAND OAKS BOULEVARD THOUSAND OAKS, CALIFORNIA (805)449-2100

VERIZON (800)483-4000 TIME WARNER CABLE

(888)892-2253


DISTRICT CONTACTS


SENIOR PARK PLANNER ANDREW MOONEY 403 WEST HILLCREST DRIVE THOUSAND OAKS, CA 91360 (805)495-6471





Call 811 before you dig. **DIG ALERT IMPORTANT NOTE:**


NO EXCAVATION OF ANY KIND IS TO OCCUR ANYWHERE ON SITE WITHOUT FIRST **VERIFYING THE LOCATIONS OF EXISTING UNDERGROUND** UTILITIES.

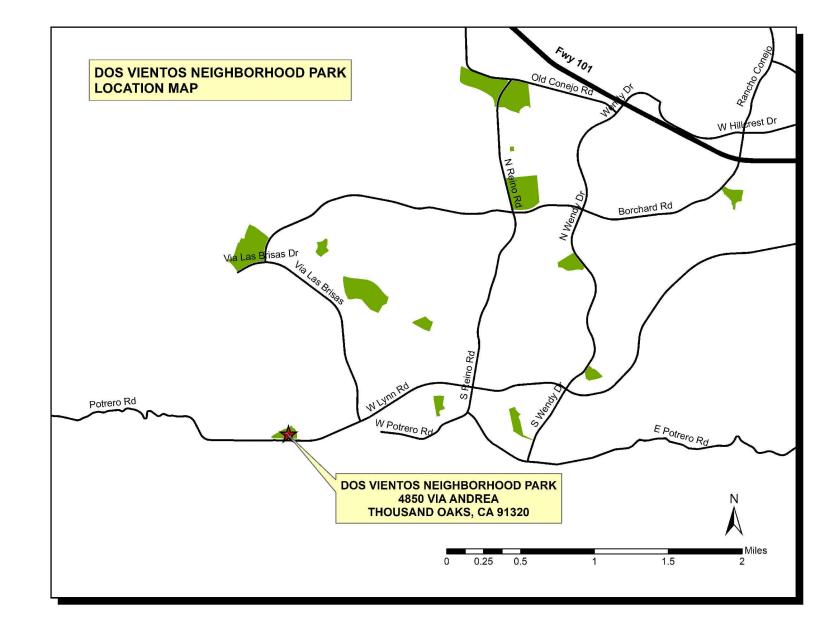

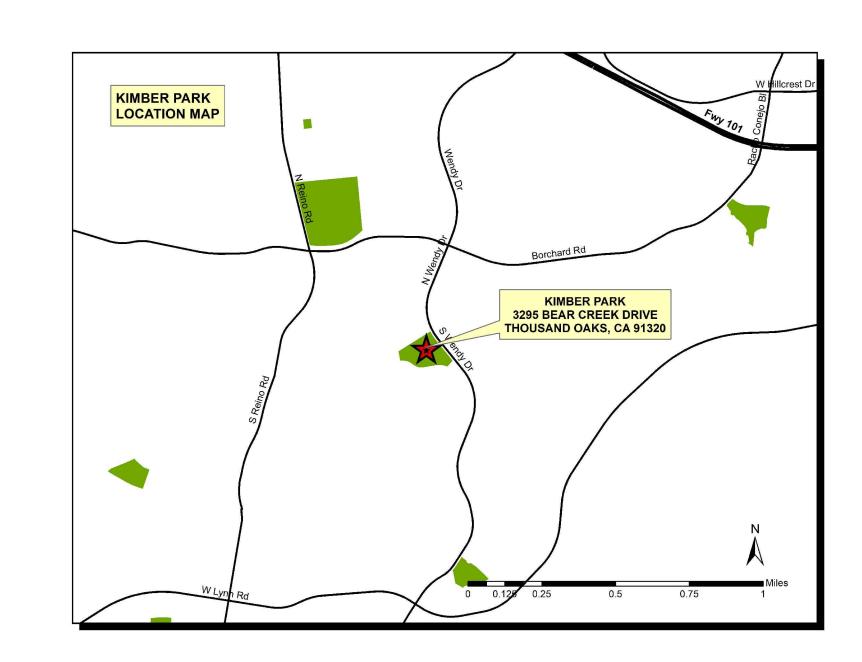

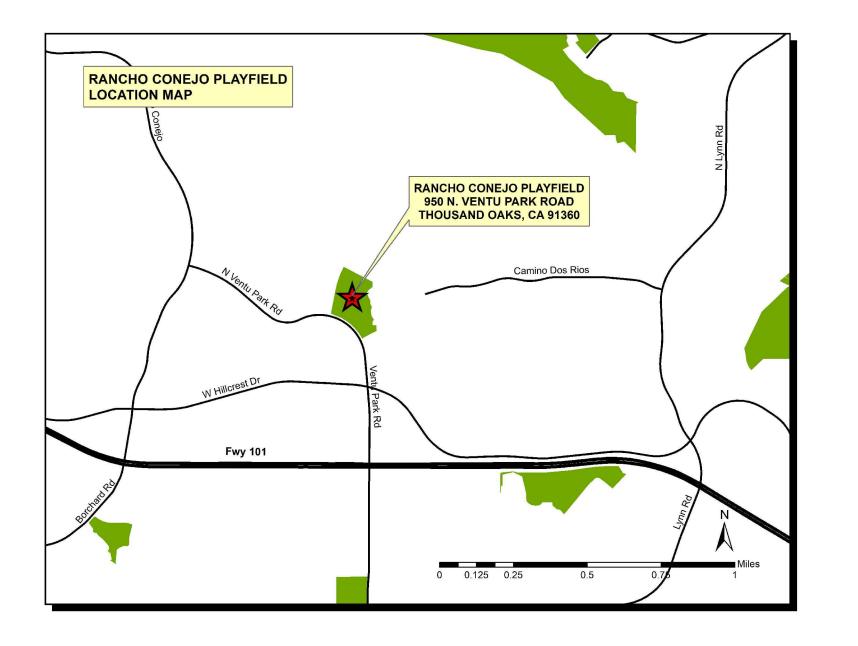

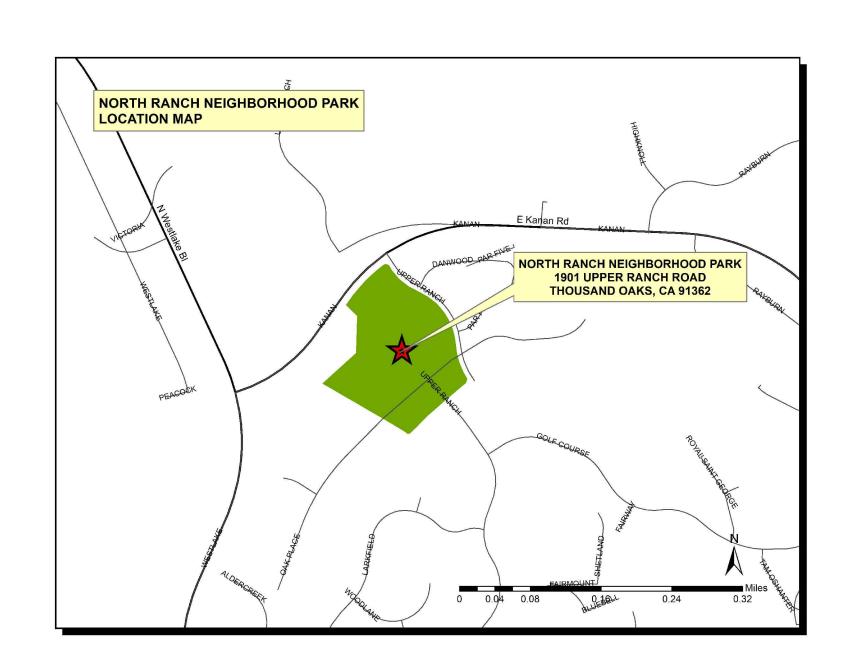

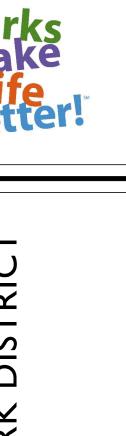


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COVER SHEET

LES JD P. OJE(Ш Оm

REVISIONS REVISIONS/ISSUE 1 DESCRIPTION DATE MAY 20, 2019 DRAWN / CHECKED PROJECT NO. DVN KIP RCP NRN

SHEET



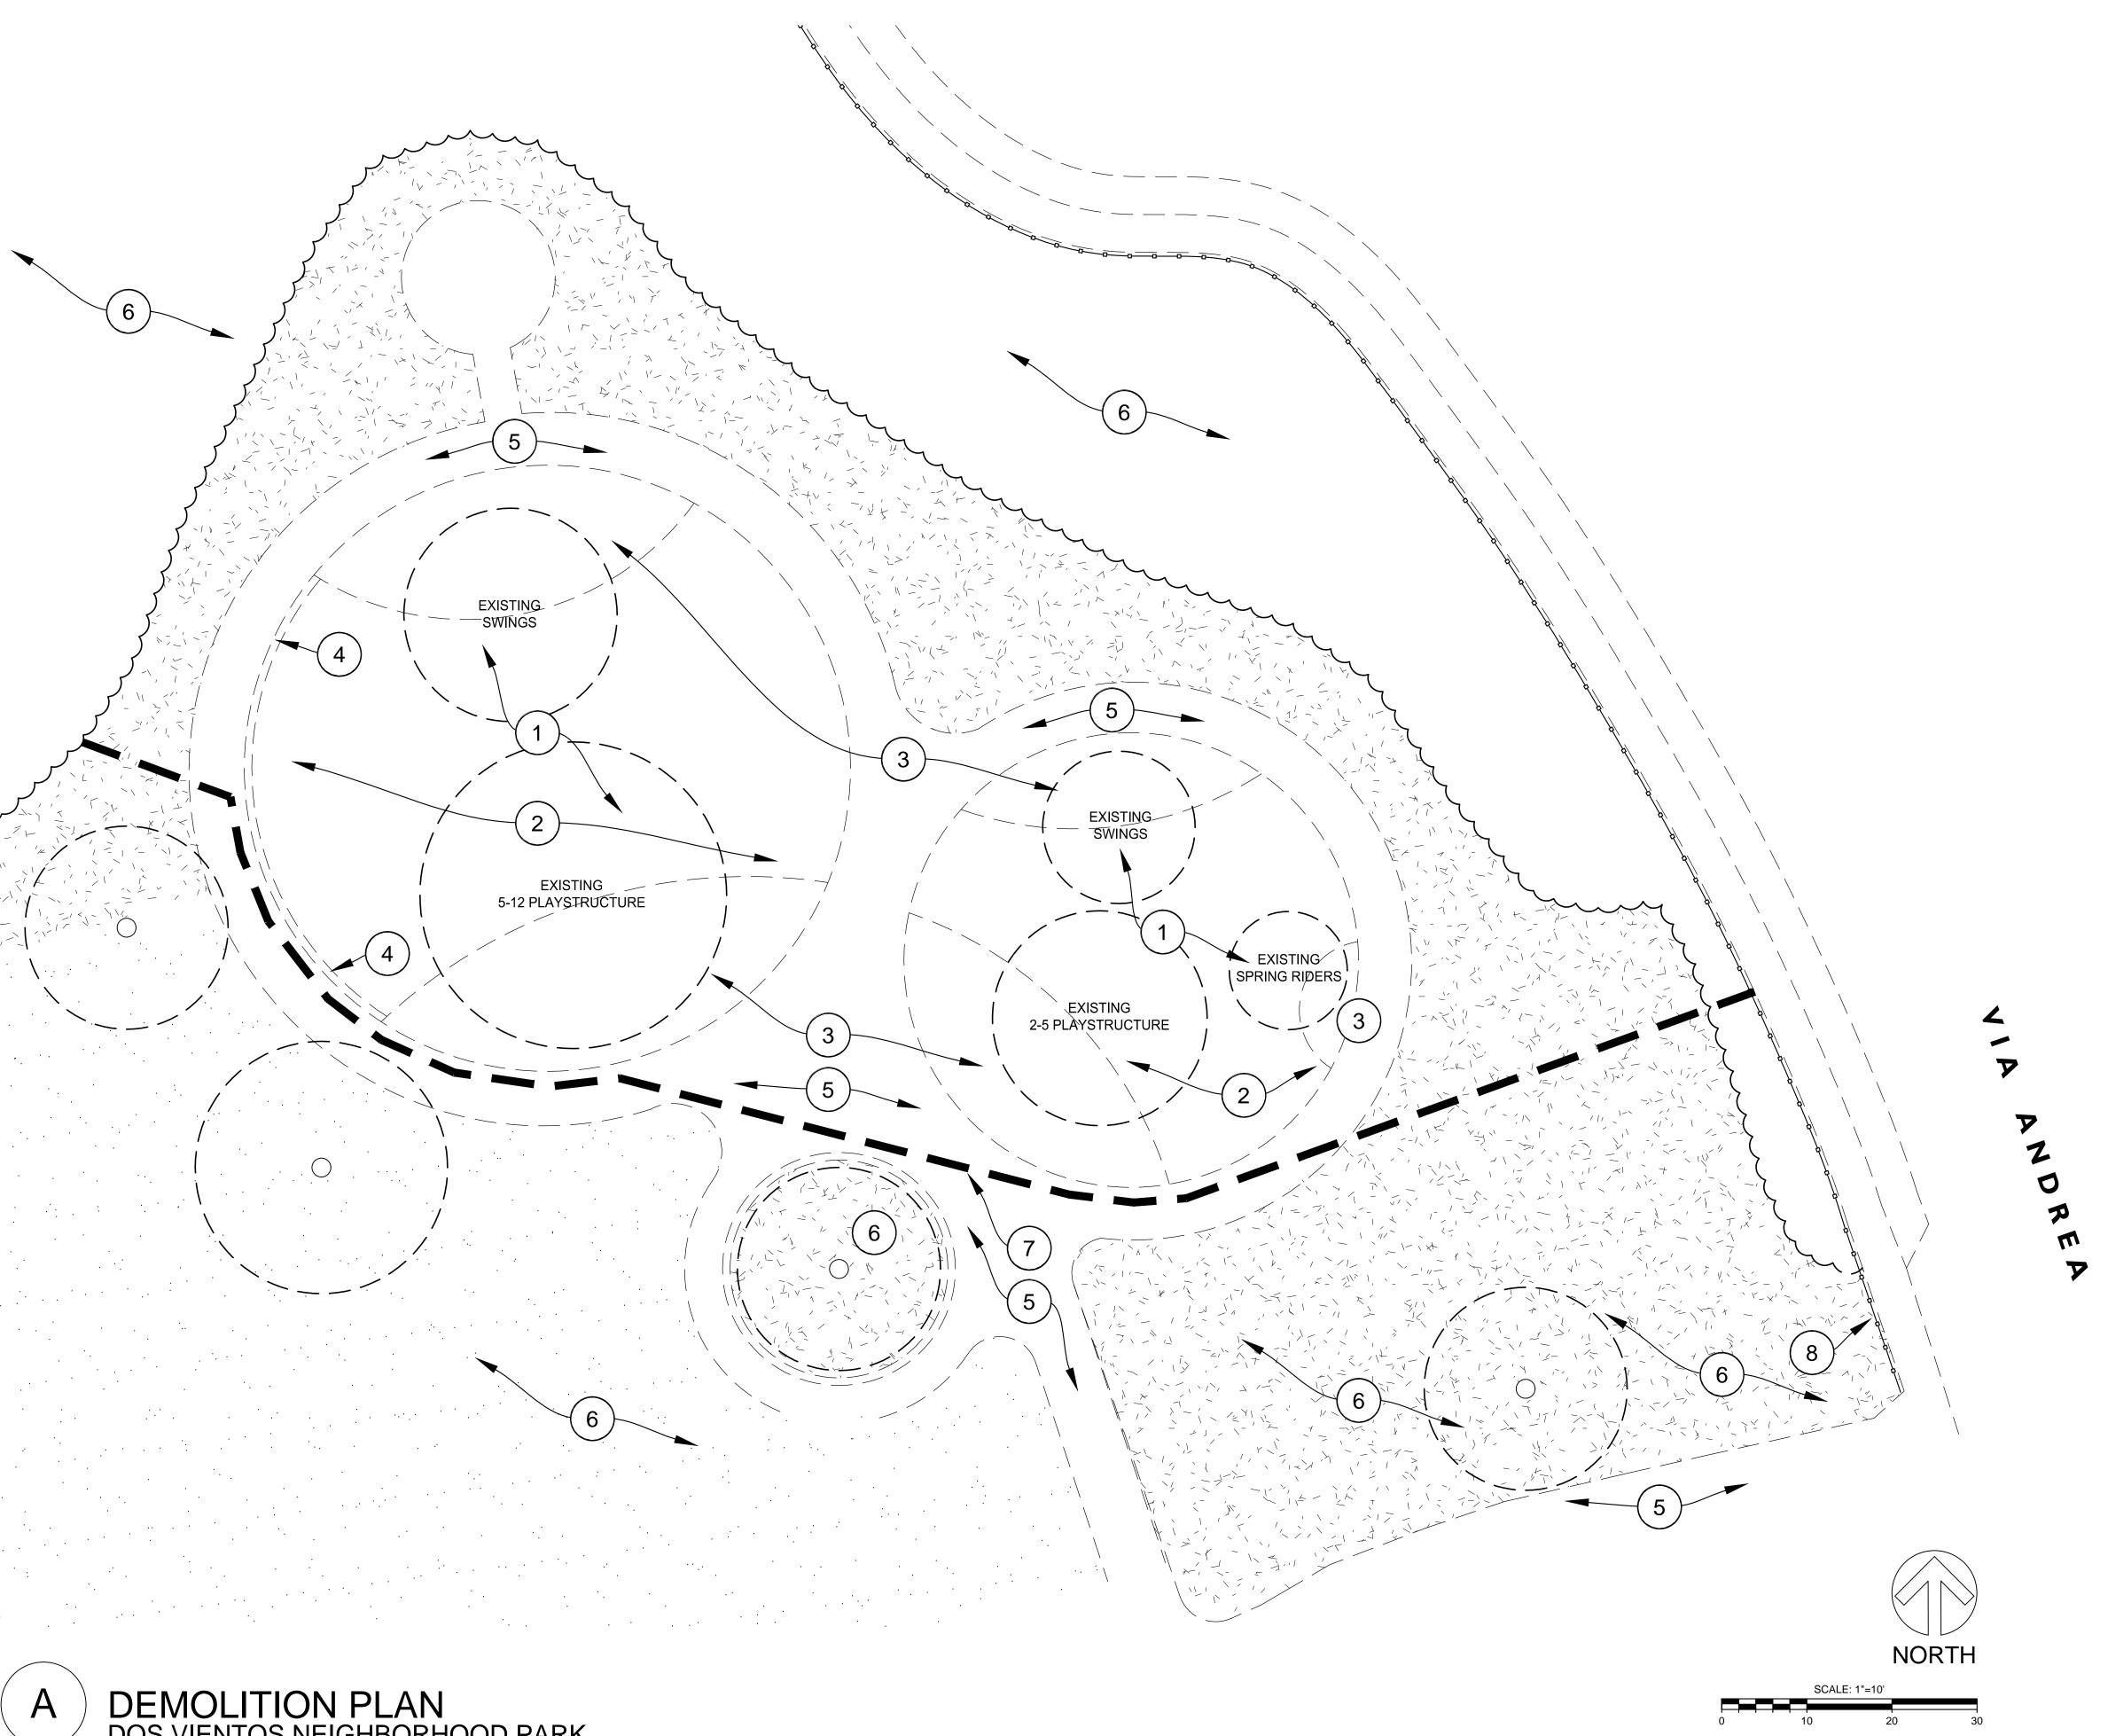

DOS VIENTOS NEIGHBORHOOD PARK

GENERAL DEMOLITION NOTES

- 1. PROTECT IN PLACE EXISTING TREES PER TREE PROTECTION NOTES THIS SHEET.
- 2. CONTRACTOR SHALL IMPLEMENT TEMPORARY PROJECT CONTROLS, INCLUDING PREPARATION AND MAINTENANCE OF BMPS AS REQUIRED. SEE TITLE SHEET.
- 3. CONTRACTOR IS RESPONSIBLE FOR REMOVAL OF ALL MATERIALS INDICATED ON PLANS.
- 4. ANY HAZARDOUS MATERIALS SHALL BE DISPOSED OF BY CONTRACTOR PRIOR TO
- GENERAL DEMOLITION. 5. UTILITY SHUTOFF SHALL BE COORDINATED BY CONTRACTOR, THE CITY OF
- THOUSAND OAKS AND DISTRICT.
- 6. WORK SHALL BE PERFORMED IN ACCORDANCE WITH CAL-OSHA CONSTRUCTION SAFETY ORDERS, MOST RECENT EDITION.
- 7. NO OPEN TRENCH SHALL BE LEFT EXPOSED WITHOUT FLAGMEN OR SECURITY
- 8. NO OPEN EXCAVATION SUCH AS TRENCH OR PLANTING PIT GREATER THAN 4 INCHES
 - DEEP WILL BE LEFT EXPOSED OR UNSECURED OVER NIGHT.
- 9. PROTECT IN PLACE EXISTING IMPROVEMENTS INCLUDING WALLS, PAVING, FENCING, PLANTING, IRRIGATION EQUIPMENT, VALVES, AND VALVE BOXES.
- 10. CONTRACTOR TO ESTABLISH INGRESS & EGRESS, & CONSTRUCTION ACCESS ROUTES TO LIMIT SITE DISTURBANCE

TREE PROTECTION NOTES

THESE TREE SPECIFICATIONS SHALL BE FOLLOWED TO PROTECT ALL TREES WHOSE DRIPLINE IS ENCROACHED UPON EITHER DIRECTLY OR INDIRECTLY BY CONSTRUCTION.

A. GENERAL REQUIREMENTS

1. NO EQUIPMENT IS TO BE PARKED UNDER A TREE, NOR ARE ANY MATERIALS TO BE STORED WITHIN THE TREE'S DRIPLINE OR LEANED AGAINST A TREE TRUNK.

2. DO NOT PILE OR COMPACT SOIL WITHIN A DRIPLINE.

- 3. DO NOT NAIL GRADE STAKES OR ANYTHING ELSE TO TREES.
- 4. DO NOT STRIP TOPSOIL. ANY VEGETATION TO BE REMOVED SHOULD BE REMOVED BY CUTTING AT GROUND LEVEL RATHER THAN PULLING OUT BY EQUIPMENT.
- 5. USE OF PNEUMATIC DRILLS IS NOT PERMISSIBLE; EXCAVATION AROUND ROOTS MUST BE PERFORMED BY HAND ONLY, NO POWER TOOLS. CUT ANY ROOTS CLEANLY WITHOUT FRAYED OR SPLIT ENDS, AND SOIL BACKFILLED IMMEDIATELY.
- 6. ALL LANDSCAPE AREAS ARE TO RECEIVE UNINTERRUPTED IRRIGATION DURING ALL CONSTRUCTION.

B. TYPICAL WORK PROCEDURES

- 1. ALL WORK AROUND ANY EXISTING TREES SHALL FOLLOW THIS WORK PROCEDURES PROGRAM. THIS PROGRAM HAS BEEN DEVELOPED TO MINIMIZE IMPACTS TO EACH TREE AND PROTECT THEM FROM UNSCHEDULED DAMAGE.
- 2. ALL WORK WITHIN A TREE'S ROOT ZONE SHALL BE AS DIRECTED BY DISTRICT STAFF.
- 3. THE EXTENT OF ALL WORK AFFECTING ANY OAKS SHALL BE STAKED BY FIELD SURVEY AND REVIEWED WITH THE DISTRICT STAFF PRIOR TO IRRIGATION

- 4. HAND DIG VERTICAL TRENCH AT THE FINAL CUT LINE TO FINAL GRADE AND CLEANLY CUT ANY ROOTS ENCOUNTERED AND SEAL WITH APPROVED TREE SEAL.
- 5. NO FURTHER WORK WITHIN THE ROOT ZONE SHALL BE DONE BEYOND WHICH WAS APPROVED, WITHOUT OBTAINING WRITTEN APPROVAL FORM DISTRICT STAFF PRIOR TO PROCEEDING.

C. DAMAGES

1. IF A TREE, DESIGNATED TO REMAIN, IS REMOVED OR CAUSED TO BE IRREVERSIBLY DAMAGED AS DETERMINED BY DISTRICT STAFF, CONTRACTOR SHALL INSTALL A REPLACEMENT TREE MATCHING SIZE, QUALITY, AND VARIETY USING AN INSTALLER DESIGNATED BY THE DISTRICT. IF AN ACCEPTABLE REPLACEMENT TREE IS NOT AVAILABLE, CONTRACTOR WILL PAY DAMAGES TO THE DISTRICT FOR THE DAMAGED TREE VALUE AS ASSESSED BY THE TREE VALUE FORMULA IN ISA GUIDE FOR ESTABLISHING VALUE OF TREES AND OTHER PLANTS.

DEMOLITION LEGENID

DEMC	DLITION LEGEND
NO.	DESCRIPTION
1	EXISTING PLAY EQUIPMENT: REMOVE AND HAUL TO RECYCLING FACILITY, INCLUDES ALL EQUIPMENT AND FOOTINGS.
2	REMOVE SAND AND SOIL TO ACCOMMODATE PLAY FIBER. REFER TO CONSTRUCTION PLAN SHEET L-3 AND DETAIL B SHEET L-8 FOR SAND/SOIL DEPTH TO BE REMOVED. SOIL TO BE HAULED TO AN OFFSITE DISPOSAL FACILITY. CLEAN SAND TO BE HAULED TO DISTRICT'S WAVERLY PARK - 1300 AVENIDA DE LAS FLORES THOUSAND OAKS, CA 91360.
3	REMOVE RUBBER PLAY SURFACING: HAUL TO RECYCLING FACILITY. INCLUDES ALL FOOTINGS AND/OR BASE. REPAIR CONCRETE CURB OR PAVING AND/OR GRIND FOR A CLEAN SMOOTH FINISH WHERE ADJACENT RUBBER SURFACE OR CONCRETE WAS REMOVED. REMOVE SOIL TO ACCOMMODATE PLAY FIBER. REFER TO CONSTRUCTION PLAN SHEET L-3 AND DETAIL B SHEET L-8.
4	EXISTING SEAT WALL TO REMAIN: PROTECT IN PLACE.
5	EXISTING CONCRETE PAVING TO REMAIN: PROTECT IN PLACE.
6	EXISTING ADJACENT PLANTING, IRRIGATION LINES AND EQUIPMENT PROTECT IN PLACE.
7	TEMPORARY CONSTRUCTION FENCE TO BE PLACED AT PERIMETER OF WORK.
8	REMOVE AND REINSTALL EXISTING WROUGHT IRON FENCE, BOULDERS, PLANTING AND IRRIGATION FOR ANY REQUIRED PROJECT ACCESS. PROTECT ALL ITEMS DURING CONSTRUCTION AND REPLACE/REPAIR ANY DAMAGE TO MEET EXISTING CONDITIONS.

CONSTRUCTION AND GRADING GENERAL NOTES

- 1. ALL WORK SHALL CONFORM TO ALL CITY, COUNTY AND OTHER GOVERNING AGENCIES' REGULATIONS FOR CONSTRUCTION, GRADING AND DRAINAGE CONTRACTOR SHALL OBTAIN ALL NECESSARY PERMITS, INSPECTIONS AND APPROVALS REQUIRED FOR THIS WORK.
- 2. FOR LOCATIONS OF EXISTING CONDITIONS, PROPERTY LINES, EASEMENTS, UTILITIES, ETC., REFER TO THE BOUNDARY AND TOPOGRAPHIC SURVEY. THE CONTRACTOR SHALL BE RESPONSIBLE FOR IDENTIFYING IN THE FIELD ALL PROPERTY LINES, EASEMENTS AND RESTRICTIONS IDENTIFIED ON THE PLANS.
- 3. THE CONTRACTOR SHALL BE RESPONSIBLE FOR THE ACCURATE LAYOUT OF THE PROJECT, FOR ESTABLISHING ALL REFERENCE POINTS, ELEVATIONS AND LINES SET FOR CONSTRUCTION, FOR CERTIFICATION OF FINISH GRADES AS SHOWN ON THE DRAWINGS, AND TO MATCH EXISTING SURFACES WHERE APPLICABLE. IF NEEDED, THE CONTRACTOR SHALL EMPLOY A REGISTERED CIVIL ENGINEER OR LICENSED LAND SURVEYOR IN ORDER TO ACCURATELY DETERMINE ALL HORIZONTAL AND VERTICAL DIMENSIONS.
- 4. CONTRACTOR SHALL VISIT THE SITE, VERIFY EXISTING CONDITIONS, BECOME FAMILIAR WITH EXISTING GRADES, SITE AND SOIL CONDITIONS.
- 5. THE CONTRACTOR SHALL NOTIFY THE DISTRICT OF ANY DISCREPANCIES BETWEEN THE ACTUAL SITE CONDITIONS AND THE PLANS PRIOR TO BEGINNING CONSTRUCTION.
- 6. WRITTEN DIMENSIONS SHALL PREVAIL OVER SCALED MEASUREMENTS ON THE PLANS AND DETAILS.
- 7. THE DISTRICT IS TO REVIEW AND APPROVE ALL LAYOUTS IN THE FIELD PRIOR TO THE START OF CONSTRUCTION.
- 8. VERIFY AND CLEARLY MARK THE LOCATION OF ALL UNDERGROUND UTILITIES AND SERVICES PRIOR TO ANY EXCAVATION. THE CONTRACTOR ASSUMES FULL RESPONSIBILITY FOR ALL DAMAGE CAUSED BY FAILURE TO DO SO.
- 9. DUST CONTROL AND EROSION & SILTATION PREVENTION SHALL BE IMPLEMENTED THROUGHOUT CONSTRUCTION AS REQUIRED BY THE GOVERNING AGENCIES, LOCAL CODES AND ORDINANCES.

WEEKLY TO HELP MAINTAIN THEIR HEALTH DURING CONSTRUCTION.

- 10. CONTRACTOR SHALL KEEP THE SITE WATERED SUFFICIENTLY TO ELIMINATE DUST NUISANCE. SPECIMEN AND EXISTING TREES TO REMAIN SHALL BE WASHED DOWN
- 11. REPORT ANY CONDITIONS WHICH PREVENT PROPER EXECUTION OF THIS WORK TO THE DISTRICT.
- 12. THE CONTRACTOR SHALL BE RESPONSIBLE FOR PROTECTING FROM DAMAGE ALL STRUCTURES, UNDERGROUND UTILITIES AND ANY EXISTING PLANT MATERIAL IDENTIFIED TO REMAIN ON THE SITE.
- 13. NO BRANCHES, LIMBS OR ROOTS OF ANY PLANT MATERIAL ARE TO BE CUT OR PRUNED WITHOUT AUTHORIZATION AND DIRECTION FROM THE ARBORIST OR HORTICULTURALIST.
- 14. ALL PLANTING AREAS SHALL BE GRADED AT A MINIMUM OF 2% AWAY FROM STRUCTURES AND TOWARD APPROPRIATE DRAINAGE INLETS, UNLESS OTHERWISE NOTED ON PLANS. FINISH GRADES SHALL BE ONE (1) INCH BELOW ADJACENT PAVING IN LAWN AREAS, AND TWO (2) INCHES BELOW ADJACENT PAVING IN SHRUB/GROUND COVER AREAS.
- 15. NEW PAVING AREAS SHALL BE SET FLUSH TO EXISTING ADJACENT PAVING SURFACES. PAVING CROSS SLOPE SHALL BE MINIMUM OF 2%.
- 16. PAVING AREA DRAINAGE SHALL BE DIRECTED AWAY FROM BUILDINGS AND STRUCTURES AT A MINIMUM OF 2 % FOR 5 FEET OR AS INDICATED ON THE DRAWINGS. ALL SURFACE FLOW SHALL BE DIRECTED TOWARD AND FLOW FREELY INTO DRAINAGE INLETS.
- 17. REFER TO PLAYGROUND MANUFACTURERS PLANS AND SPECIFICATION FOR FALL AND SAFETY ZONE. VERIFY ALL COMPONENTS AND SAFETY ZONE CONFORM TO ASTM F1487-11 AND STANDARD CONSUMER SAFETY PERFORMANCE SPECIFICATIONS FOR PLAYGROUND EQUIPMENT FOR PUBLIC USE CAN/CSA-Z614-07 - CHILDREN'S PLAYSPACES AND EQUIPMENT PRIOR TO PURCHASE AND INSTALLATION.
- 18. FINE GRADED SUBGRADE DRAINAGE SHALL BE 2% MINIMUM. FINE GRADING AROUND PLAY STRUCTURES SHALL DRAIN AWAY FROM FOOTINGS, TO THE DISTRICT'S SATISFACTION.
- 19. REPAIR AND REPLACE ANY EXISTING IMPROVEMENTS DAMAGED DURING CONSTRUCTION TO PRE-CONSTRUCTION CONDITION TO DISTRICT'S SATISFACTION. THIS INCLUDES ANY TURF AREAS ADJACENT TO WORK AND THROUGHOUT THE PROPERTY.



DEMOLITION PLAN & CONSTRUCTION NOTES

RE	VISIONS		
NO.	REVISIONS	ISSUE	DATE
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MAY 20, 2019 DRAWN / CHECKED AJM / AJM SCALE PROJECT NO. 1" = 10'-0" SHEET

SITE WITHOUT FIRST VERIFYING THE LOCATIONS OF INSTALLATION. EXISTING UNDERGROUND UTILITIES.

IMPORTANT NOTE: NO EXCAVATION OF ANY KIND IS TO OCCUR ANYWHERE ON

Know what's **below**.

Call 811 before you dig.


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GUARD.

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CONSTRUCTION PLAN




MAY 20, 2019 DRAWN / CHECKED AJM / AJM PROJECT NO. SCALE 1" = 10'-0"

SHEET

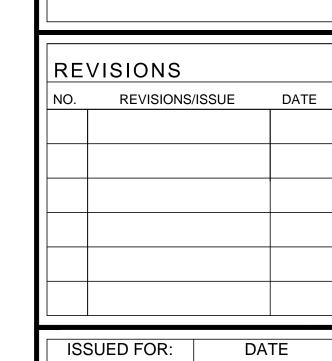

COIN2	I RUCTION LEGEND
NO.	DESCRIPTION
1	PROVIDE AND INSTALL PLAY EQUIPMENT BY PLAYWORLD. INSTALLATION TO BE PERFORMED BY NPSI CERTIFIED INSTALLER WITH AT LEAST (5) PREVIOUS INSTALLATIONS. PLAY AREA MUST MEET REQUIREMENTS FOR ASTM F1487; PUB 325. REFER TO MANUFACTURER'S PLANS. DO NOT INSTALL BIBA GAME APPLICATION - EQUIPMENT TO BE RETURNED TO MANUFACTURER
2	PROVIDE AND INSTALL ENGINEERED WOOD FIBER (EWF) 14" DEEP. MUST CONFORM TO IPEMA CERTIFIED AND ASTM F1292 AND F2075. INSTALL PERMEABLE FILTER SEPARATION CLOTH MIRAFI 140NL GEOTEXTILE BELOW EWF. SEE DRAINAGE PLAN THIS SHEET.
3	ADA CONCRETE RAMP AT PLAYGROUND. SEE DETAIL B SHEET L-8.
4	PREPARE SUBGRADE SLOPING TO GRAVEL PIT DRAIN. SEE DETAIL A SHEET L-8.
5	GRAVEL DRAINAGE PIT. SEE DETAIL A SHEET L-8.
6	EXISTING SEAT WALL TO REMAIN: PROTECT IN PLACE.
7	EXISTING CONCRETE PAVING TO REMAIN: PROTECT IN PLACE.
8	EXISTING ADJACENT PLANTING, IRRIGATION LINES AND EQUIPMENT PROTECT IN PLACE.
9	TEMPORARY CONSTRUCTION FENCE TO BE PLACED AT PERIMETER OF WORK.
10	REMOVE AND REINSTALL EXISTING WROUGHT IRON FENCE, BOULDERS, PLANTING AND IRRIGATION FOR ANY REQUIRED PROJECT ACCESS. PROTECT ALL ITEMS DURING CONSTRUCTION AND REPLACE/REPAIR ANY DAMAGE TO MEET EXISTING CONDITIONS.

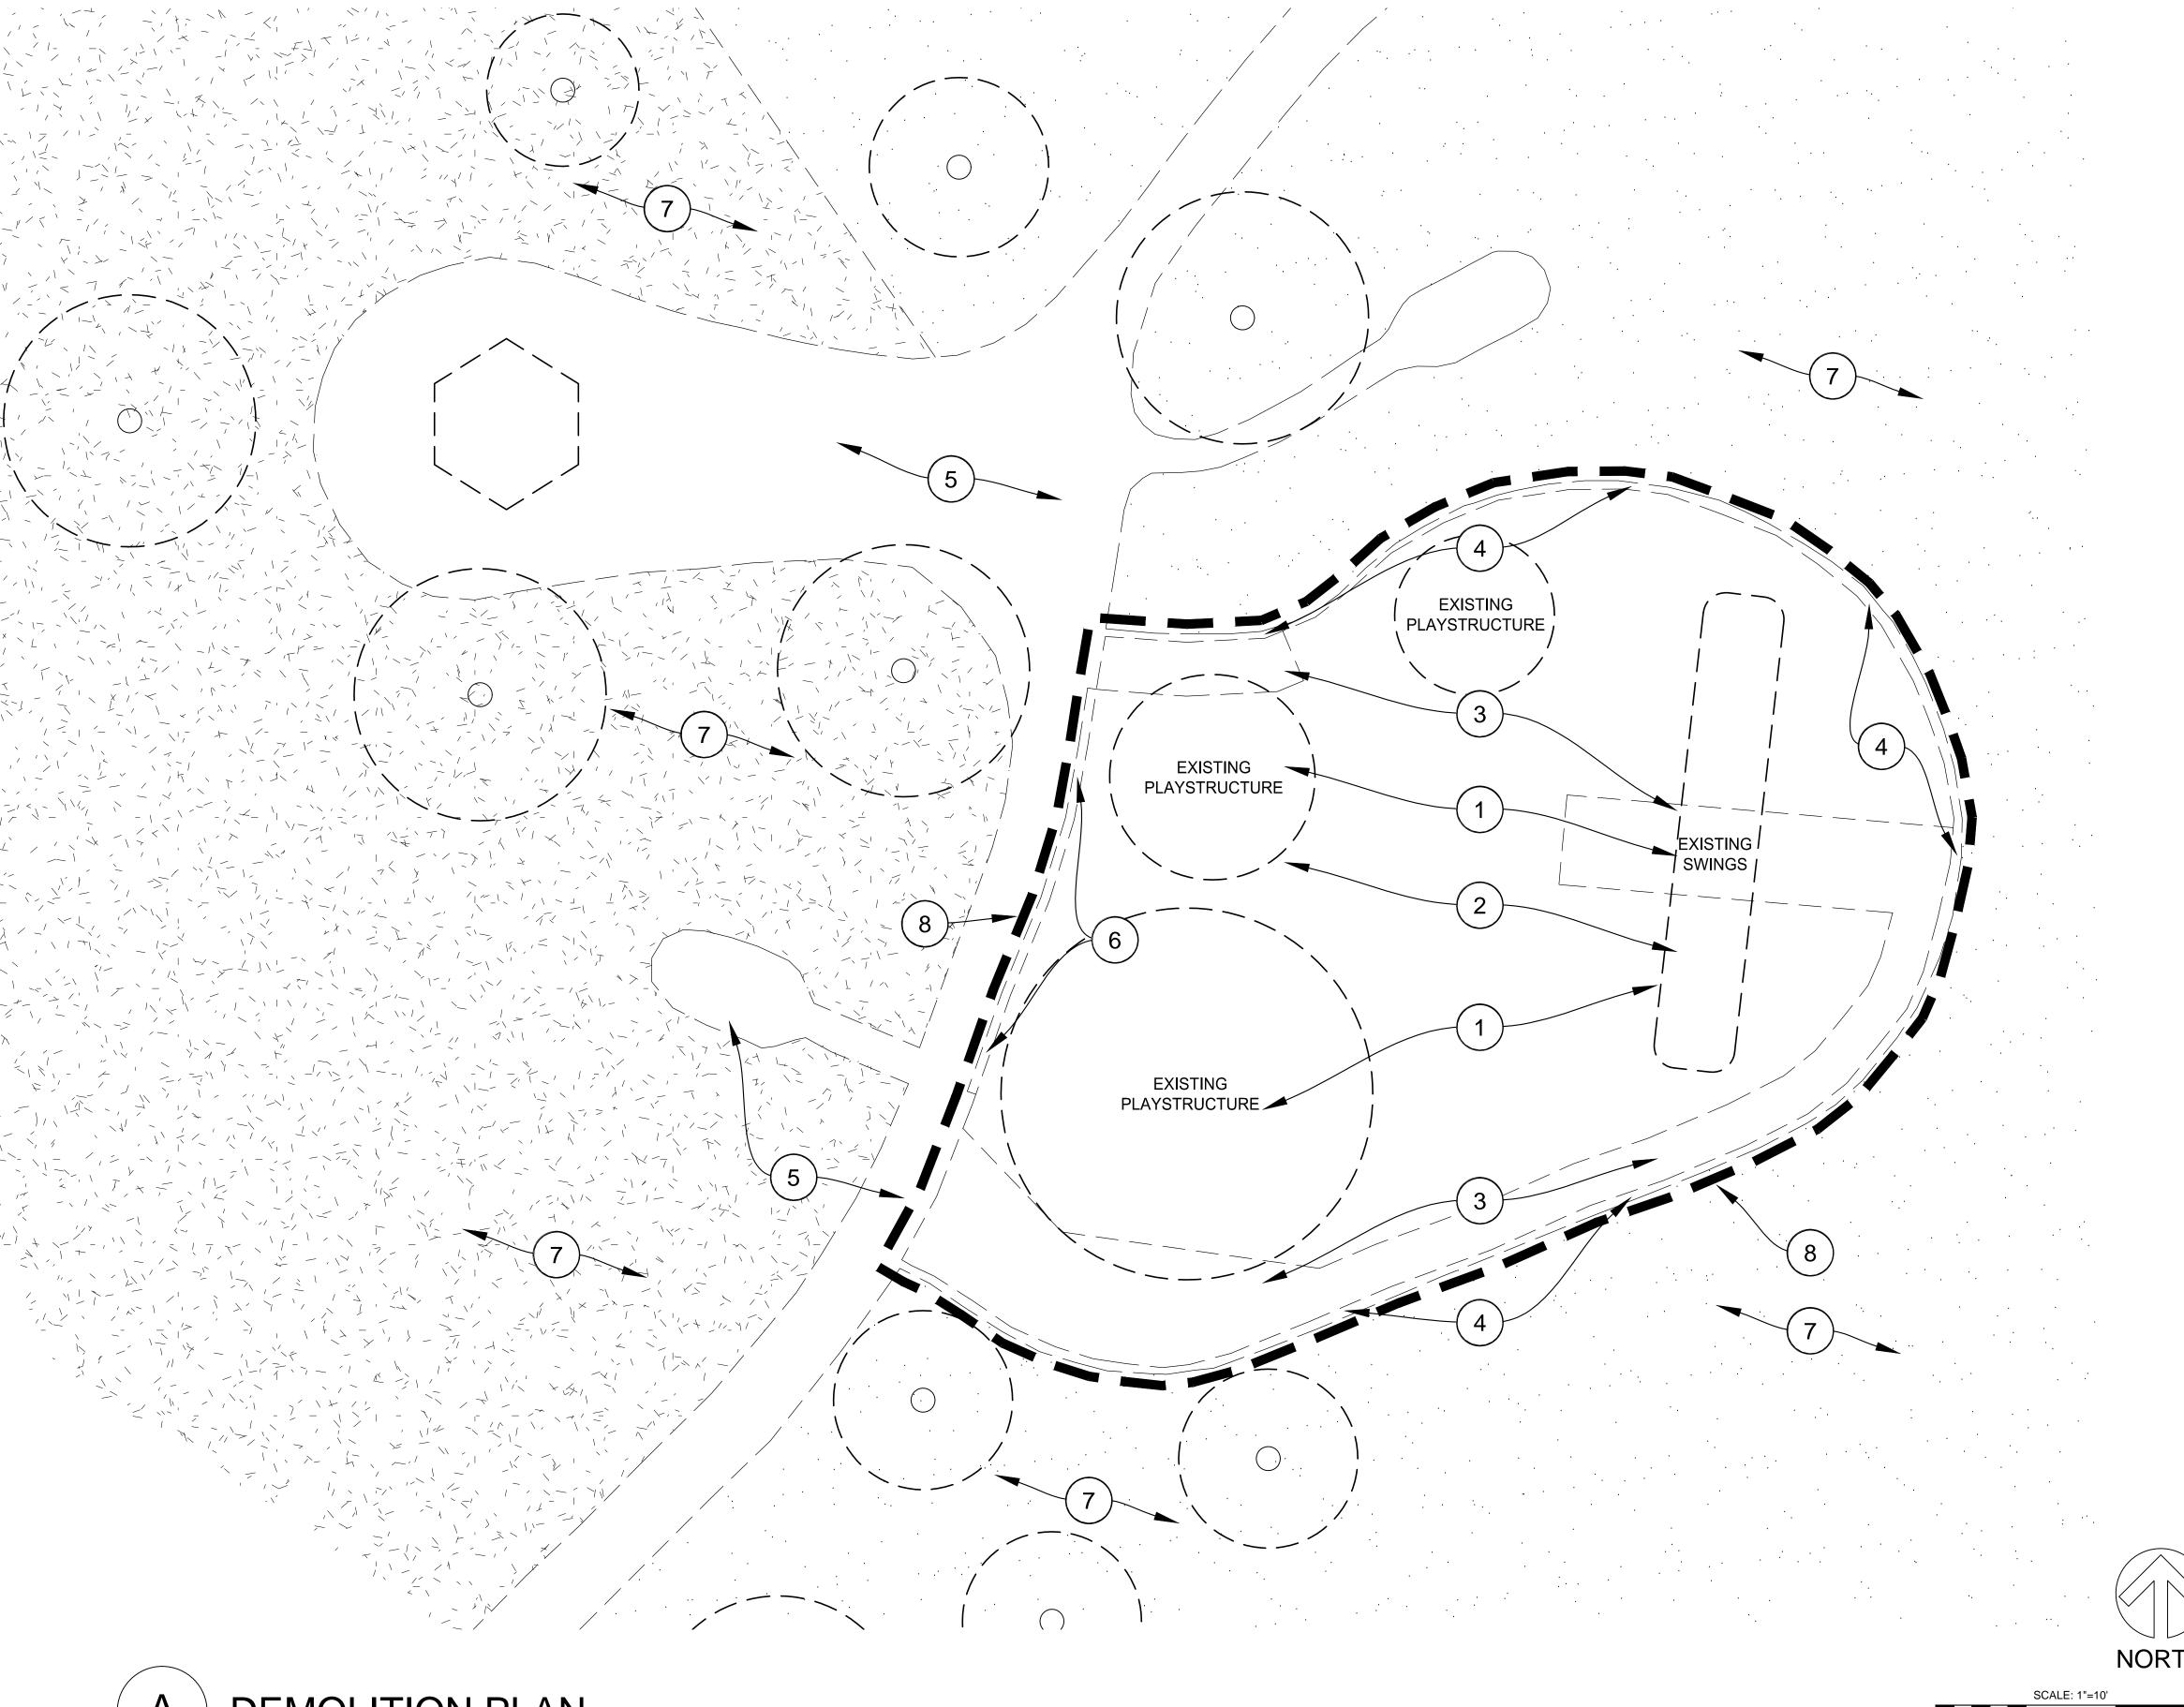



GENERAL DEMOLITION NOTES

THOUSAND OAKS AND DISTRICT.

- 1. PROTECT IN PLACE EXISTING TREES PER TREE PROTECTION NOTES THIS SHEET.
- 2. CONTRACTOR SHALL IMPLEMENT TEMPORARY PROJECT CONTROLS, INCLUDING
- 3. CONTRACTOR IS RESPONSIBLE FOR REMOVAL OF ALL MATERIALS INDICATED ON

PREPARATION AND MAINTENANCE OF BMPS AS REQUIRED. SEE TITLE SHEET.

- PLANS. 4. ANY HAZARDOUS MATERIALS SHALL BE DISPOSED OF BY CONTRACTOR PRIOR TO
- GENERAL DEMOLITION. 5. UTILITY SHUTOFF SHALL BE COORDINATED BY CONTRACTOR, THE CITY OF
- 6. WORK SHALL BE PERFORMED IN ACCORDANCE WITH CAL-OSHA CONSTRUCTION
- SAFETY ORDERS, MOST RECENT EDITION.
- 7. NO OPEN TRENCH SHALL BE LEFT EXPOSED WITHOUT FLAGMEN OR SECURITY GUARD.
- 8. NO OPEN EXCAVATION SUCH AS TRENCH OR PLANTING PIT GREATER THAN 4 INCHES DEEP WILL BE LEFT EXPOSED OR UNSECURED OVER NIGHT.
- 9. PROTECT IN PLACE EXISTING IMPROVEMENTS INCLUDING WALLS, PAVING, FENCING, PLANTING, IRRIGATION EQUIPMENT, VALVES, AND VALVE BOXES.
- 10. CONTRACTOR TO ESTABLISH INGRESS & EGRESS, & CONSTRUCTION ACCESS
- ROUTES TO LIMIT SITE DISTURBANCE

TREE PROTECTION NOTES

THESE TREE SPECIFICATIONS SHALL BE FOLLOWED TO PROTECT ALL TREES WHOSE DRIPLINE IS ENCROACHED UPON EITHER DIRECTLY OR INDIRECTLY BY CONSTRUCTION.

A. GENERAL REQUIREMENTS

- 1. NO EQUIPMENT IS TO BE PARKED UNDER A TREE, NOR ARE ANY MATERIALS TO BE STORED WITHIN THE TREE'S DRIPLINE OR LEANED AGAINST A TREE TRUNK.
- 2. DO NOT PILE OR COMPACT SOIL WITHIN A DRIPLINE.
- 3. DO NOT NAIL GRADE STAKES OR ANYTHING ELSE TO TREES.
- 4. DO NOT STRIP TOPSOIL. ANY VEGETATION TO BE REMOVED SHOULD BE REMOVED BY CUTTING AT GROUND LEVEL RATHER THAN PULLING OUT BY EQUIPMENT.
- 5. USE OF PNEUMATIC DRILLS IS NOT PERMISSIBLE; EXCAVATION AROUND ROOTS MUST BE PERFORMED BY HAND ONLY, NO POWER TOOLS. CUT ANY ROOTS CLEANLY WITHOUT FRAYED OR SPLIT ENDS, AND SOIL BACKFILLED IMMEDIATELY.
- 6. ALL LANDSCAPE AREAS ARE TO RECEIVE UNINTERRUPTED IRRIGATION DURING ALL
- B. TYPICAL WORK PROCEDURES

CONSTRUCTION.

- 1. ALL WORK AROUND ANY EXISTING TREES SHALL FOLLOW THIS WORK PROCEDURES PROGRAM. THIS PROGRAM HAS BEEN DEVELOPED TO MINIMIZE IMPACTS TO EACH TREE AND PROTECT THEM FROM UNSCHEDULED DAMAGE.
- 2. ALL WORK WITHIN A TREE'S ROOT ZONE SHALL BE AS DIRECTED BY DISTRICT STAFF.
- 3. THE EXTENT OF ALL WORK AFFECTING ANY OAKS SHALL BE STAKED BY FIELD SURVEY AND REVIEWED WITH THE DISTRICT STAFF PRIOR TO IRRIGATION INSTALLATION.

- 4. HAND DIG VERTICAL TRENCH AT THE FINAL CUT LINE TO FINAL GRADE AND CLEANLY CUT ANY ROOTS ENCOUNTERED AND SEAL WITH APPROVED TREE SEAL.
- 5. NO FURTHER WORK WITHIN THE ROOT ZONE SHALL BE DONE BEYOND WHICH WAS APPROVED, WITHOUT OBTAINING WRITTEN APPROVAL FORM DISTRICT STAFF PRIOR TO PROCEEDING.

C. DAMAGES

1. IF A TREE, DESIGNATED TO REMAIN, IS REMOVED OR CAUSED TO BE IRREVERSIBLY DAMAGED AS DETERMINED BY DISTRICT STAFF, CONTRACTOR SHALL INSTALL A REPLACEMENT TREE MATCHING SIZE, QUALITY, AND VARIETY USING AN INSTALLER DESIGNATED BY THE DISTRICT. IF AN ACCEPTABLE REPLACEMENT TREE IS NOT AVAILABLE, CONTRACTOR WILL PAY DAMAGES TO THE DISTRICT FOR THE DAMAGED TREE VALUE AS ASSESSED BY THE TREE VALUE FORMULA IN ISA GUIDE FOR ESTABLISHING VALUE OF TREES AND OTHER PLANTS.

DEMOLITION LEGEND

DLITO	LITION LEGEND
NO.	DESCRIPTION
1	EXISTING PLAY EQUIPMENT: REMOVE AND HAUL TO RECYCLING FACILITY, INCLUDES ALL EQUIPMENT AND FOOTINGS.
2	REMOVE SAND AND SOIL TO ACCOMMODATE PLAY FIBER. REFER TO CONSTRUCTION PLAN SHEET L-5 AND DETAIL B SHEET L-8 FOR SAND/SOIL DEPTH TO BE REMOVED. SOIL TO BE HAULED TO AN OFFSITE DISPOSAL FACILITY. CLEAN SAND TO BE HAULED TO DISTRICT'S WAVERLY PARK - 1300 AVENIDA DE LAS FLORES THOUSAND OAKS, CA 91360.
3	RUBBER PLAY SURFACING: REMOVE AND HAUL TO RECYCLING FACILITY. INCLUDES ALL FOOTINGS AND/OR BASE. ADJACENT CONCRETE CURB TO REMAIN: PROTECT IN PLACE.
4	EXISTING CONCRETE CURB TO REMAIN: PROTECT IN PLACE.
5	EXISTING CONCRETE PAVING TO REMAIN: PROTECT IN PLACE.
6	EXISTING CONCRETE SEATWALL TO REMAIN: PROTECT IN PLACE.
7	EXISTING ADJACENT PLANTING, IRRIGATION LINES AND EQUIPMENT PROTECT IN PLACE.
8	TEMPORARY CONSTRUCTION FENCE TO BE PLACED AT PERIMETER OF WORK.
	NO. 1 2 3 4 5 6 7

CONSTRUCTION AND GRADING GENERAL NOTES

START OF CONSTRUCTION.

CODES AND ORDINANCES.

- ETC., REFER TO THE BOUNDARY AND TOPOGRAPHIC SURVEY. THE CONTRACTOR SHALL BE RESPONSIBLE FOR IDENTIFYING IN THE FIELD ALL PROPERTY LINES. EASEMENTS AND RESTRICTIONS IDENTIFIED ON THE PLANS
- 3. THE CONTRACTOR SHALL BE RESPONSIBLE FOR THE ACCURATE LAYOUT OF THE PROJECT, FOR ESTABLISHING ALL REFERENCE POINTS, ELEVATIONS AND LINES SET FOR CONSTRUCTION, FOR CERTIFICATION OF FINISH GRADES AS SHOWN ON THE DRAWINGS, AND TO MATCH EXISTING SURFACES WHERE APPLICABLE. IF NEEDED. THE CONTRACTOR SHALL EMPLOY A REGISTERED CIVIL ENGINEER OR LICENSED LAND SURVEYOR IN ORDER TO ACCURATELY DETERMINE ALL HORIZONTAL AND VERTICAL DIMENSIONS.
- 4. CONTRACTOR SHALL VISIT THE SITE, VERIFY EXISTING CONDITIONS, BECOME FAMILIAR WITH EXISTING GRADES, SITE AND SOIL CONDITIONS.
- 5. THE CONTRACTOR SHALL NOTIFY THE DISTRICT OF ANY DISCREPANCIES BETWEEN THE ACTUAL SITE CONDITIONS AND THE PLANS PRIOR TO BEGINNING CONSTRUCTION.
- 6. WRITTEN DIMENSIONS SHALL PREVAIL OVER SCALED MEASUREMENTS ON THE PLANS AND DETAILS.
- 7. THE DISTRICT IS TO REVIEW AND APPROVE ALL LAYOUTS IN THE FIELD PRIOR TO THE
- 8. VERIFY AND CLEARLY MARK THE LOCATION OF ALL UNDERGROUND UTILITIES AND SERVICES PRIOR TO ANY EXCAVATION. THE CONTRACTOR ASSUMES FULL

RESPONSIBILITY FOR ALL DAMAGE CAUSED BY FAILURE TO DO SO.

- 9. DUST CONTROL AND EROSION & SILTATION PREVENTION SHALL BE IMPLEMENTED THROUGHOUT CONSTRUCTION AS REQUIRED BY THE GOVERNING AGENCIES, LOCAL
- 10. CONTRACTOR SHALL KEEP THE SITE WATERED SUFFICIENTLY TO ELIMINATE DUST NUISANCE. SPECIMEN AND EXISTING TREES TO REMAIN SHALL BE WASHED DOWN WEEKLY TO HELP MAINTAIN THEIR HEALTH DURING CONSTRUCTION.
- 11. REPORT ANY CONDITIONS WHICH PREVENT PROPER EXECUTION OF THIS WORK TO THE DISTRICT.
- 12. THE CONTRACTOR SHALL BE RESPONSIBLE FOR PROTECTING FROM DAMAGE ALL STRUCTURES, UNDERGROUND UTILITIES AND ANY EXISTING PLANT MATERIAL IDENTIFIED TO REMAIN ON THE SITE.
- 13. NO BRANCHES, LIMBS OR ROOTS OF ANY PLANT MATERIAL ARE TO BE CUT OR PRUNED WITHOUT AUTHORIZATION AND DIRECTION FROM THE ARBORIST OR HORTICULTURALIST.
- 14. ALL PLANTING AREAS SHALL BE GRADED AT A MINIMUM OF 2% AWAY FROM STRUCTURES AND TOWARD APPROPRIATE DRAINAGE INLETS, UNLESS OTHERWISE NOTED ON PLANS. FINISH GRADES SHALL BE ONE (1) INCH BELOW ADJACENT PAVING IN LAWN AREAS, AND TWO (2) INCHES BELOW ADJACENT PAVING IN SHRUB/GROUND COVER AREAS.
- 15. NEW PAVING AREAS SHALL BE SET FLUSH TO EXISTING ADJACENT PAVING SURFACES. PAVING CROSS SLOPE SHALL BE MINIMUM OF 2%.
- 16. PAVING AREA DRAINAGE SHALL BE DIRECTED AWAY FROM BUILDINGS AND STRUCTURES AT A MINIMUM OF 2 % FOR 5 FEET OR AS INDICATED ON THE DRAWINGS. ALL SURFACE FLOW SHALL BE DIRECTED TOWARD AND FLOW FREELY INTO DRAINAGE INLETS.
- 17. REFER TO PLAYGROUND MANUFACTURERS PLANS AND SPECIFICATION FOR FALL AND SAFETY ZONE. VERIFY ALL COMPONENTS AND SAFETY ZONE CONFORM TO ASTM F1487-11 AND STANDARD CONSUMER SAFETY PERFORMANCE SPECIFICATIONS FOR PLAYGROUND EQUIPMENT FOR PUBLIC USE CAN/CSA-Z614-07 - CHILDREN'S PLAYSPACES AND EQUIPMENT PRIOR TO PURCHASE AND INSTALLATION.
- 18. FINE GRADED SUBGRADE DRAINAGE SHALL BE 2% MINIMUM. FINE GRADING AROUND PLAY STRUCTURES SHALL DRAIN AWAY FROM FOOTINGS, TO THE DISTRICT'S SATISFACTION.
- 19. REPAIR AND REPLACE ANY EXISTING IMPROVEMENTS DAMAGED DURING CONSTRUCTION TO PRE-CONSTRUCTION CONDITION TO DISTRICT'S SATISFACTION. THIS INCLUDES ANY TURF AREAS ADJACENT TO WORK AND THROUGHOUT THE PROPERTY.





DEMOLITION PLAN & CONSTRUCTION NOTES

NO.	REVISIONS/	'ISSUE	DATE

DRAWN / CHECKED PROJECT NO. SCALE 1" = 10'-0" SHEET


IMPORTANT NOTE: NO EXCAVATION OF ANY KIND IS TO OCCUR ANYWHERE ON SITE WITHOUT FIRST VERIFYING THE LOCATIONS OF

Know what's **below**.

Call 811 before you dig.

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EXISTING UNDERGROUND UTILITIES. C:\Users\amooney\Conejo Recreation & Park District\Parks Administration - Documents\PROJECTS\ACTIVE\DVN KIP RCP PLAYGROUNDS\Drawings\CRPD\3 CD\L-2 - L-8 DEMOLITION & CONSTRUCTION.dwg 30X42 Monday, May 20, 2019 11:28:50 AM

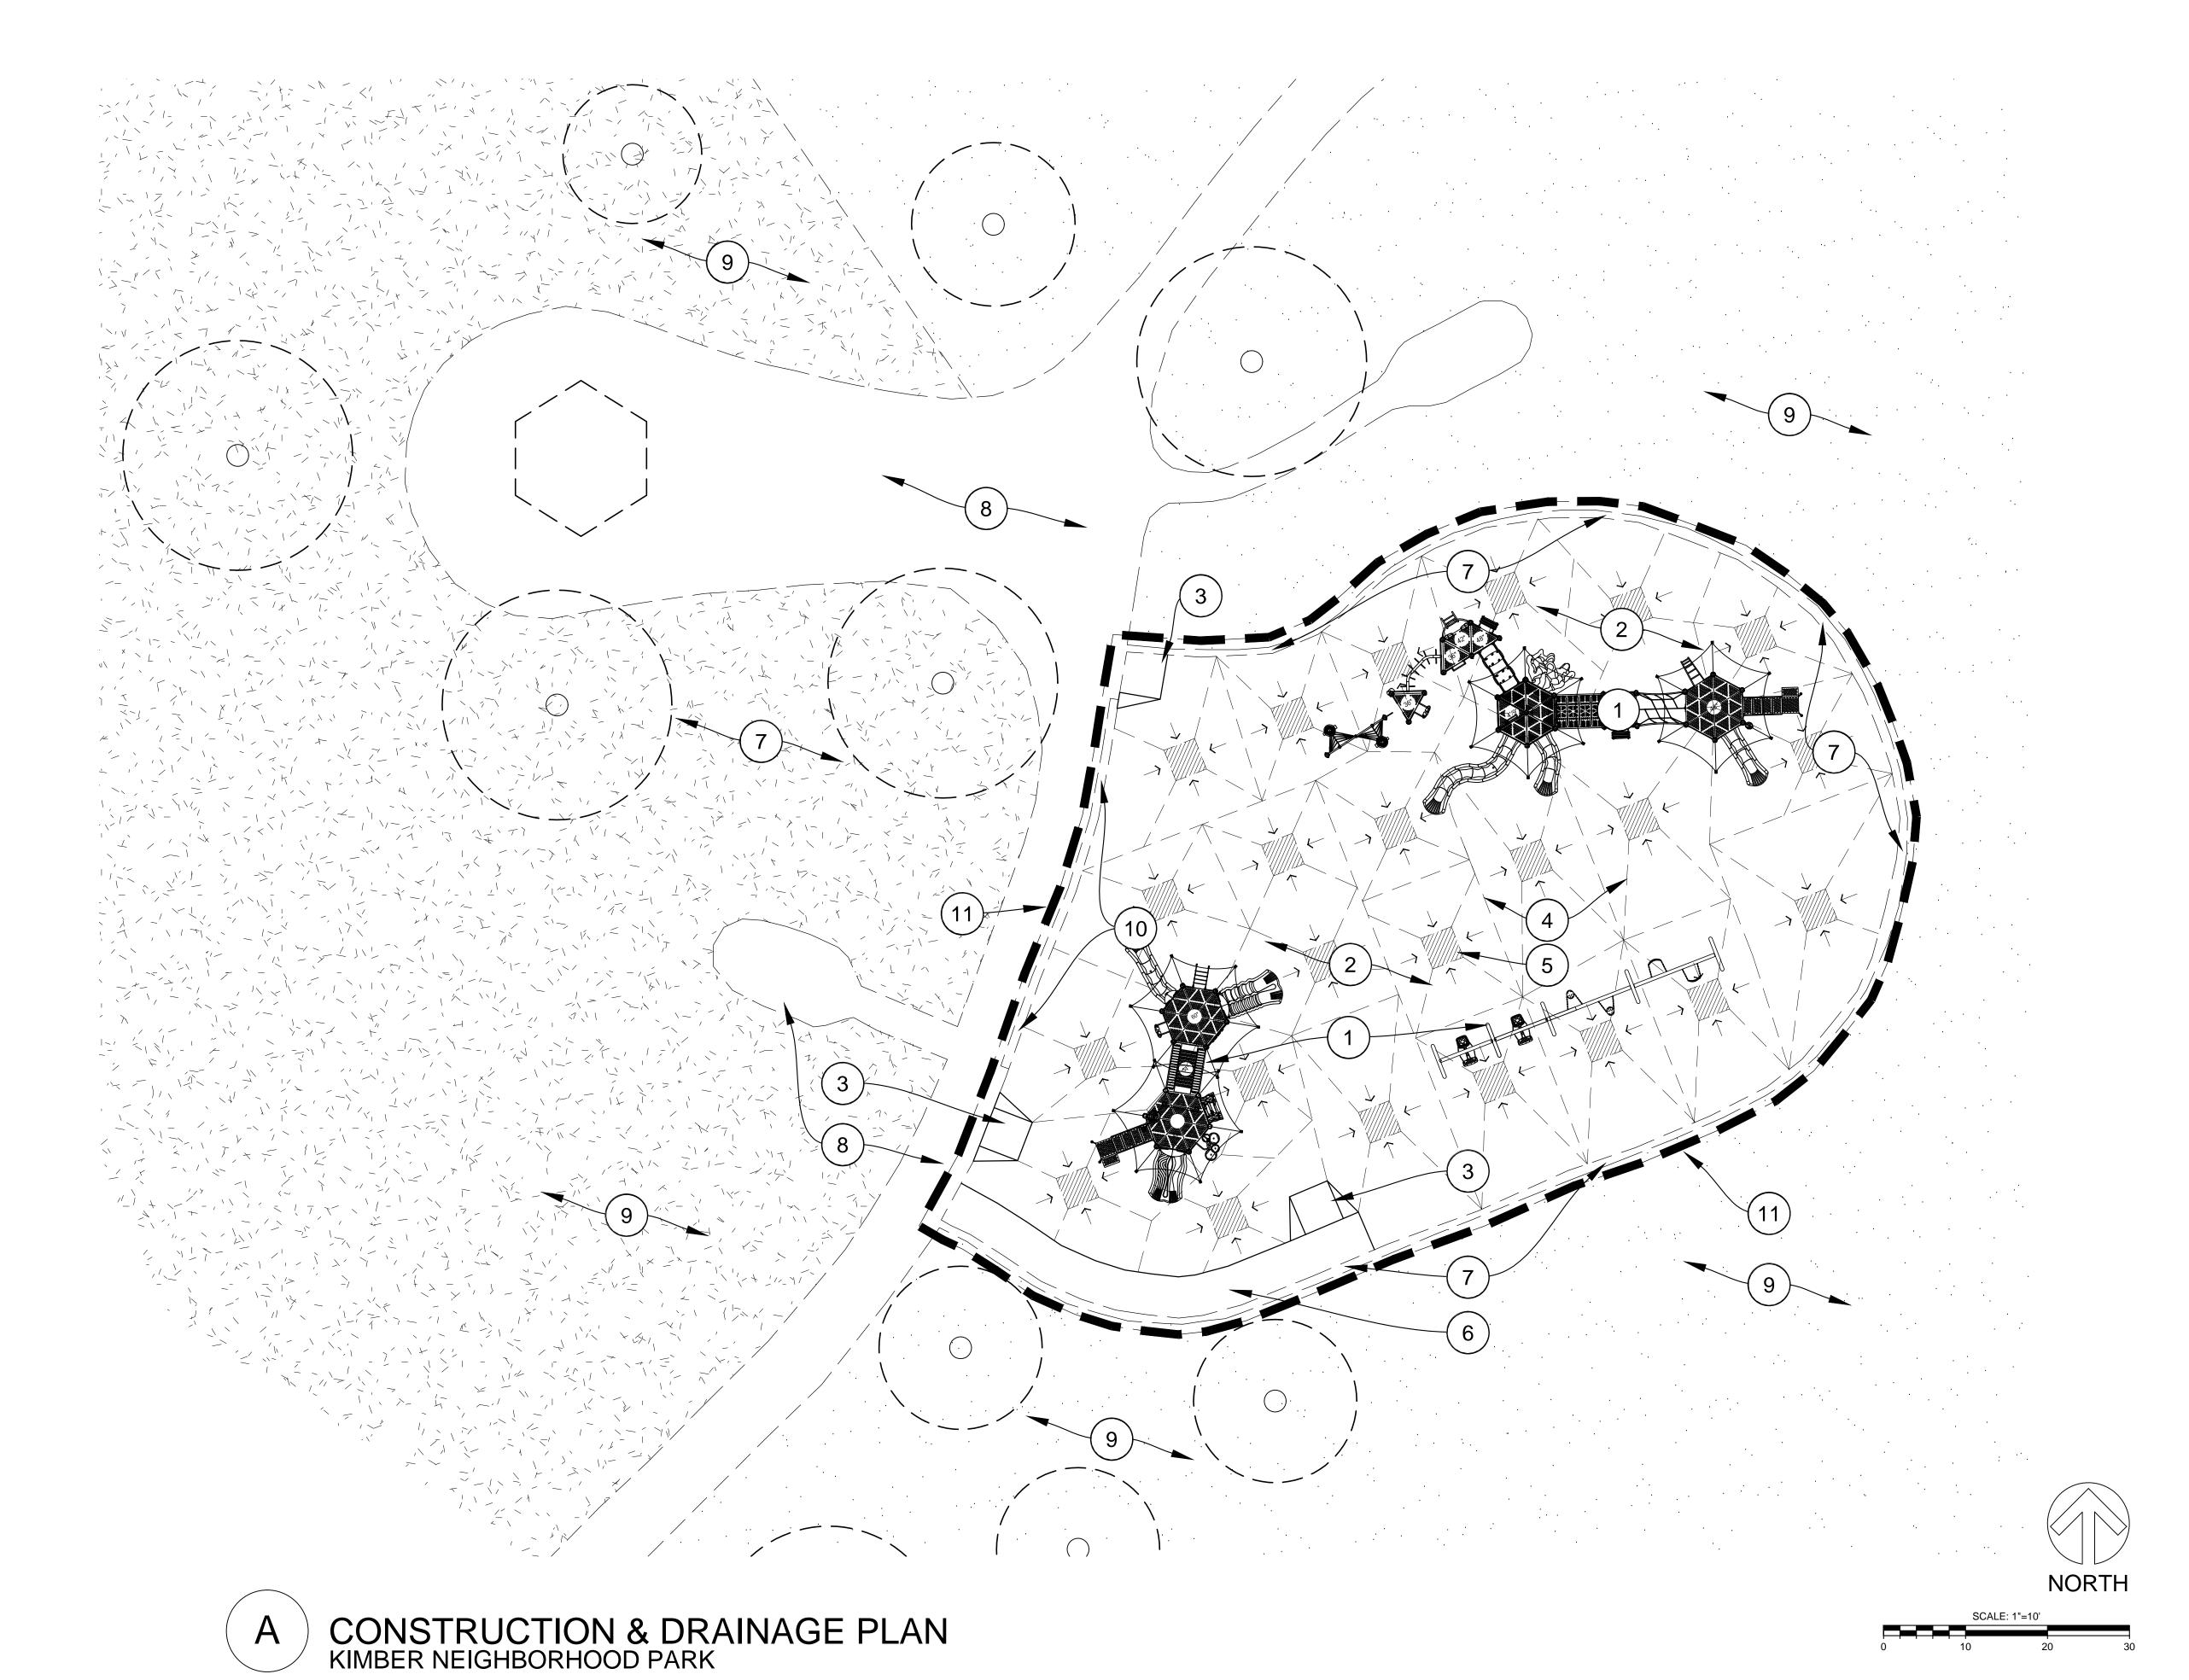

CONSTRUCTION LEGEND

CO142	13 I RUCTION LEGEND			
NO.	DESCRIPTION			
1	PROVIDE AND INSTALL PLAY EQUIPMENT BY PLAYWORLD. INSTALLATION TO BE PERFORMED BY NPSI CERTIFIED INSTALLER WITH AT LEAST (5) PREVIOUS INSTALLATIONS. PLAY AREA MUST MEET REQUIREMENTS FOR ASTM F1487; PUB 325. REFER TO MANUFACTURER'S PLANS. DO NOT INSTALL BIBA GAME APPLICATION - EQUIPMENT TO BE RETURNED TO MANUFACTURER			
2	PROVIDE AND INSTALL ENGINEERED WOOD FIBER (EWF) 14" DEEP. MUST CONFORM TO IPEMA CERTIFIED AND ASTM F1292 AND F2075. INSTALL PERMEABLE FILTER SEPARATION CLOTH MIRAFI 140NL GEOTEXTILE BELOW EWF. SEE DRAINAGE PLAN THIS SHEET.			
3	ADA CONCRETE RAMP AT PLAYGROUND. SEE DETAIL B SHEET L-8.			
4	PREPARE SUBGRADE SLOPING TO GRAVEL PIT DRAIN. SEE DETAIL A SHEET L-8.			
5	GRAVEL DRAINAGE PIT. SEE DETAIL A SHEET L-8.			
6	CONCRETE PATHWAY WITH DEEPENED EDGE PER PLAN A THIS SHEET AND DETAIL C SHEET L-8. TYPICAL EDGE TO BE 12" DEEP / EDGE AT PLAYGROUND/FIBER TO BE 16" DEEP. PATHWAY TO BE LAID OUT IN THE FIELD PRIOR TO CONSTRUCTION. STANDARD GRAY COLOR - MEDIUM BROOM FINISH.			
7	EXISTING CONCRETE CURB TO REMAIN: PROTECT IN PLACE.			
8	EXISTING CONCRETE PAVING TO REMAIN: PROTECT IN PLACE.			
9	EXISTING ADJACENT PLANTING, IRRIGATION LINES AND EQUIPMENT PROTECT IN PLACE.			
10	EXISTING CONCRETE SEATWALL TO REMAIN: PROTECT IN PLACE.			



CONSTRUCTION PLAN

REV	ISIONS		
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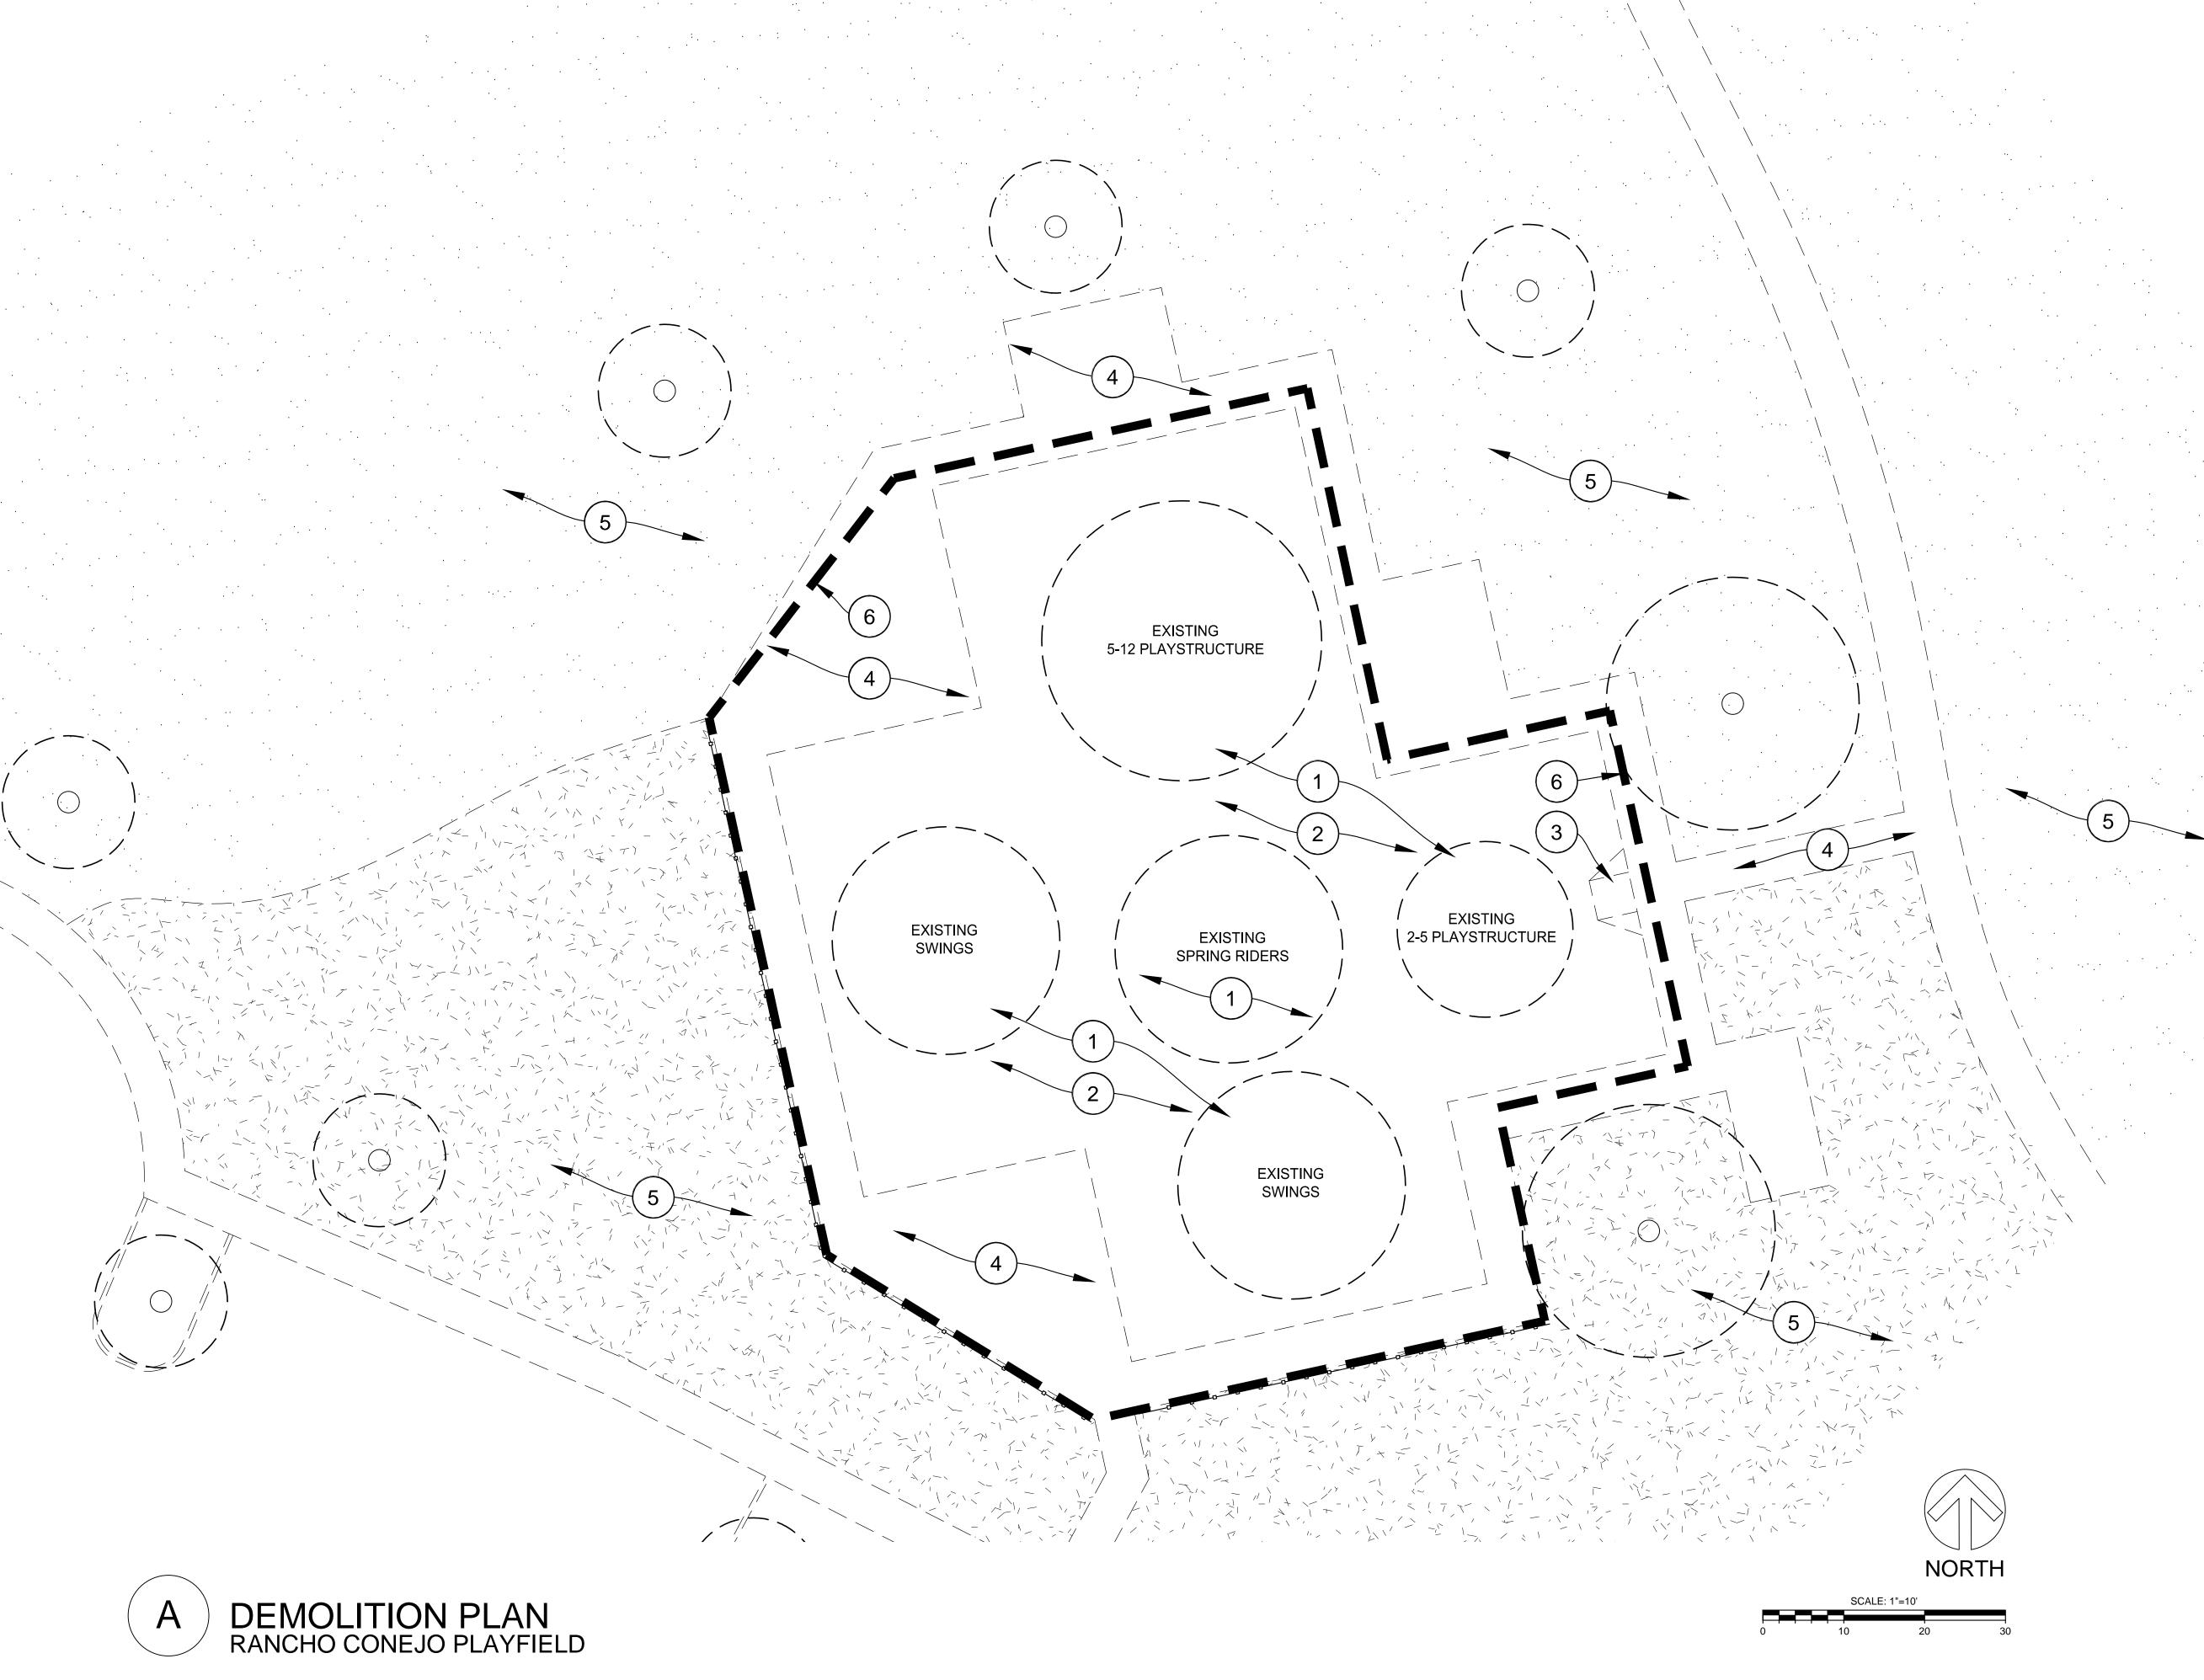
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IMPORTANT NOTE: NO EXCAVATION OF ANY KIND IS TO OCCUR ANYWHERE ON SITE WITHOUT FIRST VERIFYING THE LOCATIONS OF

EXISTING UNDERGROUND UTILITIES. C:\Users\amooney\Conejo Recreation & Park District\Parks Administration - Documents\PROJECTS\ACTIVE\DVN KIP RCP PLAYGROUNDS\Drawings\CRPD\3 CD\L-2 - L-8 DEMOLITION & CONSTRUCTION.dwg 30X42 Tuesday, May 21, 2019 10:15:12



GENERAL DEMOLITION NOTES

THOUSAND OAKS AND DISTRICT.

- 1. PROTECT IN PLACE EXISTING TREES PER TREE PROTECTION NOTES THIS SHEET.
- 2. CONTRACTOR SHALL IMPLEMENT TEMPORARY PROJECT CONTROLS, INCLUDING PREPARATION AND MAINTENANCE OF BMPS AS REQUIRED. SEE TITLE SHEET.
- 3. CONTRACTOR IS RESPONSIBLE FOR REMOVAL OF ALL MATERIALS INDICATED ON PLANS.
- 4. ANY HAZARDOUS MATERIALS SHALL BE DISPOSED OF BY CONTRACTOR PRIOR TO
- GENERAL DEMOLITION. 5. UTILITY SHUTOFF SHALL BE COORDINATED BY CONTRACTOR, THE CITY OF
- 6. WORK SHALL BE PERFORMED IN ACCORDANCE WITH CAL-OSHA CONSTRUCTION
- SAFETY ORDERS, MOST RECENT EDITION.
- 7. NO OPEN TRENCH SHALL BE LEFT EXPOSED WITHOUT FLAGMEN OR SECURITY GUARD.
- 8. NO OPEN EXCAVATION SUCH AS TRENCH OR PLANTING PIT GREATER THAN 4 INCHES DEEP WILL BE LEFT EXPOSED OR UNSECURED OVER NIGHT.
- 9. PROTECT IN PLACE EXISTING IMPROVEMENTS INCLUDING WALLS, PAVING, FENCING, PLANTING, IRRIGATION EQUIPMENT, VALVES, AND VALVE BOXES.
- 10. CONTRACTOR TO ESTABLISH INGRESS & EGRESS, & CONSTRUCTION ACCESS
- ROUTES TO LIMIT SITE DISTURBANCE

TREE PROTECTION NOTES

THESE TREE SPECIFICATIONS SHALL BE FOLLOWED TO PROTECT ALL TREES WHOSE DRIPLINE IS ENCROACHED UPON EITHER DIRECTLY OR INDIRECTLY BY CONSTRUCTION.

A. GENERAL REQUIREMENTS

- 1. NO EQUIPMENT IS TO BE PARKED UNDER A TREE, NOR ARE ANY MATERIALS TO BE STORED WITHIN THE TREE'S DRIPLINE OR LEANED AGAINST A TREE TRUNK.
- 2. DO NOT PILE OR COMPACT SOIL WITHIN A DRIPLINE.
- 3. DO NOT NAIL GRADE STAKES OR ANYTHING ELSE TO TREES.
- 4. DO NOT STRIP TOPSOIL. ANY VEGETATION TO BE REMOVED SHOULD BE REMOVED BY CUTTING AT GROUND LEVEL RATHER THAN PULLING OUT BY EQUIPMENT.
- 5. USE OF PNEUMATIC DRILLS IS NOT PERMISSIBLE; EXCAVATION AROUND ROOTS MUST BE PERFORMED BY HAND ONLY, NO POWER TOOLS. CUT ANY ROOTS CLEANLY WITHOUT FRAYED OR SPLIT ENDS, AND SOIL BACKFILLED IMMEDIATELY.
- 6. ALL LANDSCAPE AREAS ARE TO RECEIVE UNINTERRUPTED IRRIGATION DURING ALL CONSTRUCTION.

B. TYPICAL WORK PROCEDURES

- 1. ALL WORK AROUND ANY EXISTING TREES SHALL FOLLOW THIS WORK PROCEDURES PROGRAM. THIS PROGRAM HAS BEEN DEVELOPED TO MINIMIZE IMPACTS TO EACH TREE AND PROTECT THEM FROM UNSCHEDULED DAMAGE.
- 2. ALL WORK WITHIN A TREE'S ROOT ZONE SHALL BE AS DIRECTED BY DISTRICT STAFF.
- 3. THE EXTENT OF ALL WORK AFFECTING ANY OAKS SHALL BE STAKED BY FIELD SURVEY AND REVIEWED WITH THE DISTRICT STAFF PRIOR TO IRRIGATION INSTALLATION.

- 4. HAND DIG VERTICAL TRENCH AT THE FINAL CUT LINE TO FINAL GRADE AND CLEANLY CUT ANY ROOTS ENCOUNTERED AND SEAL WITH APPROVED TREE SEAL.
- 5. NO FURTHER WORK WITHIN THE ROOT ZONE SHALL BE DONE BEYOND WHICH WAS APPROVED, WITHOUT OBTAINING WRITTEN APPROVAL FORM DISTRICT STAFF PRIOR TO PROCEEDING.

C. DAMAGES

1. IF A TREE, DESIGNATED TO REMAIN, IS REMOVED OR CAUSED TO BE IRREVERSIBLY DAMAGED AS DETERMINED BY DISTRICT STAFF, CONTRACTOR SHALL INSTALL A REPLACEMENT TREE MATCHING SIZE, QUALITY, AND VARIETY USING AN INSTALLER DESIGNATED BY THE DISTRICT. IF AN ACCEPTABLE REPLACEMENT TREE IS NOT AVAILABLE. CONTRACTOR WILL PAY DAMAGES TO THE DISTRICT FOR THE DAMAGED TREE VALUE AS ASSESSED BY THE TREE VALUE FORMULA IN ISA GUIDE FOR ESTABLISHING VALUE OF TREES AND OTHER PLANTS.

DEMOLITION LEGEND

NO.	DESCRIPTION	
1	EXISTING PLAY EQUIPMENT: REMOVE AND HAUL TO RECYCLING FACILITY, INCLUDES ALL EQUIPMENT AND FOOTINGS.	
2	REMOVE EXISTING PLAY FIBER AND SOIL TO ACCOMMODATE PROPER DEPTH. OF PLAY FIBER. REFER TO CONSTRUCTION PLAN SHEET L-7 AND DETAIL B SHEET L-8 FOR SOIL DEPTH TO BE REMOVED. SOIL TO BE HAULED TO AN OFFSITE DISPOSAL FACILITY. EXISTING FIBER TO BE STOCKPILED ON SITE AND REINSTALLED - ADDITIONAL FIBER TO BE ORDERED FOR PROPER DEPTH PER DETAIL B SHEET L-8.	
3	EXISTING CONCRETE RAMP TO REMAIN: PROTECT IN PLACE.	
4	EXISTING CONCRETE PAVING TO REMAIN: PROTECT IN PLACE.	
5	EXISTING ADJACENT PLANTING, IRRIGATION LINES AND EQUIPMENT PROTECT IN PLACE.	
6	TEMPORARY CONSTRUCTION FENCE TO BE PLACED AT PERIMETER OF WORK.	

CONSTRUCTION AND GRADING GENERAL NOTES

- AGENCIES' REGULATIONS FOR CONSTRUCTION, GRADING AND DRAINAGE CONTRACTOR SHALL OBTAIN ALL NECESSARY PERMITS, INSPECTIONS AND APPROVALS REQUIRED FOR THIS WORK.
- 2. FOR LOCATIONS OF EXISTING CONDITIONS, PROPERTY LINES, EASEMENTS, UTILITIES, ETC., REFER TO THE BOUNDARY AND TOPOGRAPHIC SURVEY. THE CONTRACTOR SHALL BE RESPONSIBLE FOR IDENTIFYING IN THE FIELD ALL PROPERTY LINES, EASEMENTS AND RESTRICTIONS IDENTIFIED ON THE PLANS.
- 3. THE CONTRACTOR SHALL BE RESPONSIBLE FOR THE ACCURATE LAYOUT OF THE PROJECT, FOR ESTABLISHING ALL REFERENCE POINTS, ELEVATIONS AND LINES SET FOR CONSTRUCTION, FOR CERTIFICATION OF FINISH GRADES AS SHOWN ON THE DRAWINGS, AND TO MATCH EXISTING SURFACES WHERE APPLICABLE. IF NEEDED, THE CONTRACTOR SHALL EMPLOY A REGISTERED CIVIL ENGINEER OR LICENSED LAND SURVEYOR IN ORDER TO ACCURATELY DETERMINE ALL HORIZONTAL AND VERTICAL DIMENSIONS.
- 4. CONTRACTOR SHALL VISIT THE SITE, VERIFY EXISTING CONDITIONS, BECOME FAMILIAR WITH EXISTING GRADES, SITE AND SOIL CONDITIONS.
- 5. THE CONTRACTOR SHALL NOTIFY THE DISTRICT OF ANY DISCREPANCIES BETWEEN THE ACTUAL SITE CONDITIONS AND THE PLANS PRIOR TO BEGINNING CONSTRUCTION.
- 6. WRITTEN DIMENSIONS SHALL PREVAIL OVER SCALED MEASUREMENTS ON THE PLANS AND DETAILS.
- 7. THE DISTRICT IS TO REVIEW AND APPROVE ALL LAYOUTS IN THE FIELD PRIOR TO THE START OF CONSTRUCTION.
- 8. VERIFY AND CLEARLY MARK THE LOCATION OF ALL UNDERGROUND UTILITIES AND SERVICES PRIOR TO ANY EXCAVATION. THE CONTRACTOR ASSUMES FULL RESPONSIBILITY FOR ALL DAMAGE CAUSED BY FAILURE TO DO SO.

WEEKLY TO HELP MAINTAIN THEIR HEALTH DURING CONSTRUCTION.

- 9. DUST CONTROL AND EROSION & SILTATION PREVENTION SHALL BE IMPLEMENTED THROUGHOUT CONSTRUCTION AS REQUIRED BY THE GOVERNING AGENCIES, LOCAL CODES AND ORDINANCES.
- 10. CONTRACTOR SHALL KEEP THE SITE WATERED SUFFICIENTLY TO ELIMINATE DUST NUISANCE. SPECIMEN AND EXISTING TREES TO REMAIN SHALL BE WASHED DOWN
- 11. REPORT ANY CONDITIONS WHICH PREVENT PROPER EXECUTION OF THIS WORK TO THE DISTRICT.
- 12. THE CONTRACTOR SHALL BE RESPONSIBLE FOR PROTECTING FROM DAMAGE ALL STRUCTURES, UNDERGROUND UTILITIES AND ANY EXISTING PLANT MATERIAL IDENTIFIED TO REMAIN ON THE SITE.
- 13. NO BRANCHES, LIMBS OR ROOTS OF ANY PLANT MATERIAL ARE TO BE CUT OR PRUNED WITHOUT AUTHORIZATION AND DIRECTION FROM THE ARBORIST OR HORTICULTURALIST.
- 14. ALL PLANTING AREAS SHALL BE GRADED AT A MINIMUM OF 2% AWAY FROM STRUCTURES AND TOWARD APPROPRIATE DRAINAGE INLETS, UNLESS OTHERWISE NOTED ON PLANS. FINISH GRADES SHALL BE ONE (1) INCH BELOW ADJACENT PAVING IN LAWN AREAS, AND TWO (2) INCHES BELOW ADJACENT PAVING IN SHRUB/GROUND COVER AREAS.
- 15. NEW PAVING AREAS SHALL BE SET FLUSH TO EXISTING ADJACENT PAVING SURFACES. PAVING CROSS SLOPE SHALL BE MINIMUM OF 2%.
- 16. PAVING AREA DRAINAGE SHALL BE DIRECTED AWAY FROM BUILDINGS AND STRUCTURES AT A MINIMUM OF 2 % FOR 5 FEET OR AS INDICATED ON THE DRAWINGS. ALL SURFACE FLOW SHALL BE DIRECTED TOWARD AND FLOW FREELY INTO DRAINAGE INLETS.
- 17. REFER TO PLAYGROUND MANUFACTURERS PLANS AND SPECIFICATION FOR FALL AND SAFETY ZONE. VERIFY ALL COMPONENTS AND SAFETY ZONE CONFORM TO ASTM F1487-11 AND STANDARD CONSUMER SAFETY PERFORMANCE SPECIFICATIONS FOR PLAYGROUND EQUIPMENT FOR PUBLIC USE CAN/CSA-Z614-07 - CHILDREN'S PLAYSPACES AND EQUIPMENT PRIOR TO PURCHASE AND INSTALLATION.
- 18. FINE GRADED SUBGRADE DRAINAGE SHALL BE 2% MINIMUM. FINE GRADING AROUND PLAY STRUCTURES SHALL DRAIN AWAY FROM FOOTINGS, TO THE DISTRICT'S SATISFACTION.
- 19. REPAIR AND REPLACE ANY EXISTING IMPROVEMENTS DAMAGED DURING CONSTRUCTION TO PRE-CONSTRUCTION CONDITION TO DISTRICT'S SATISFACTION. THIS INCLUDES ANY TURF AREAS ADJACENT TO WORK AND THROUGHOUT THE PROPERTY.





DEMOLITION PLAN & CONSTRUCTION NOTES

REVISIONS REVISIONS/ISSUE DATE **ISSUED FOR:** MAY 20, 2019

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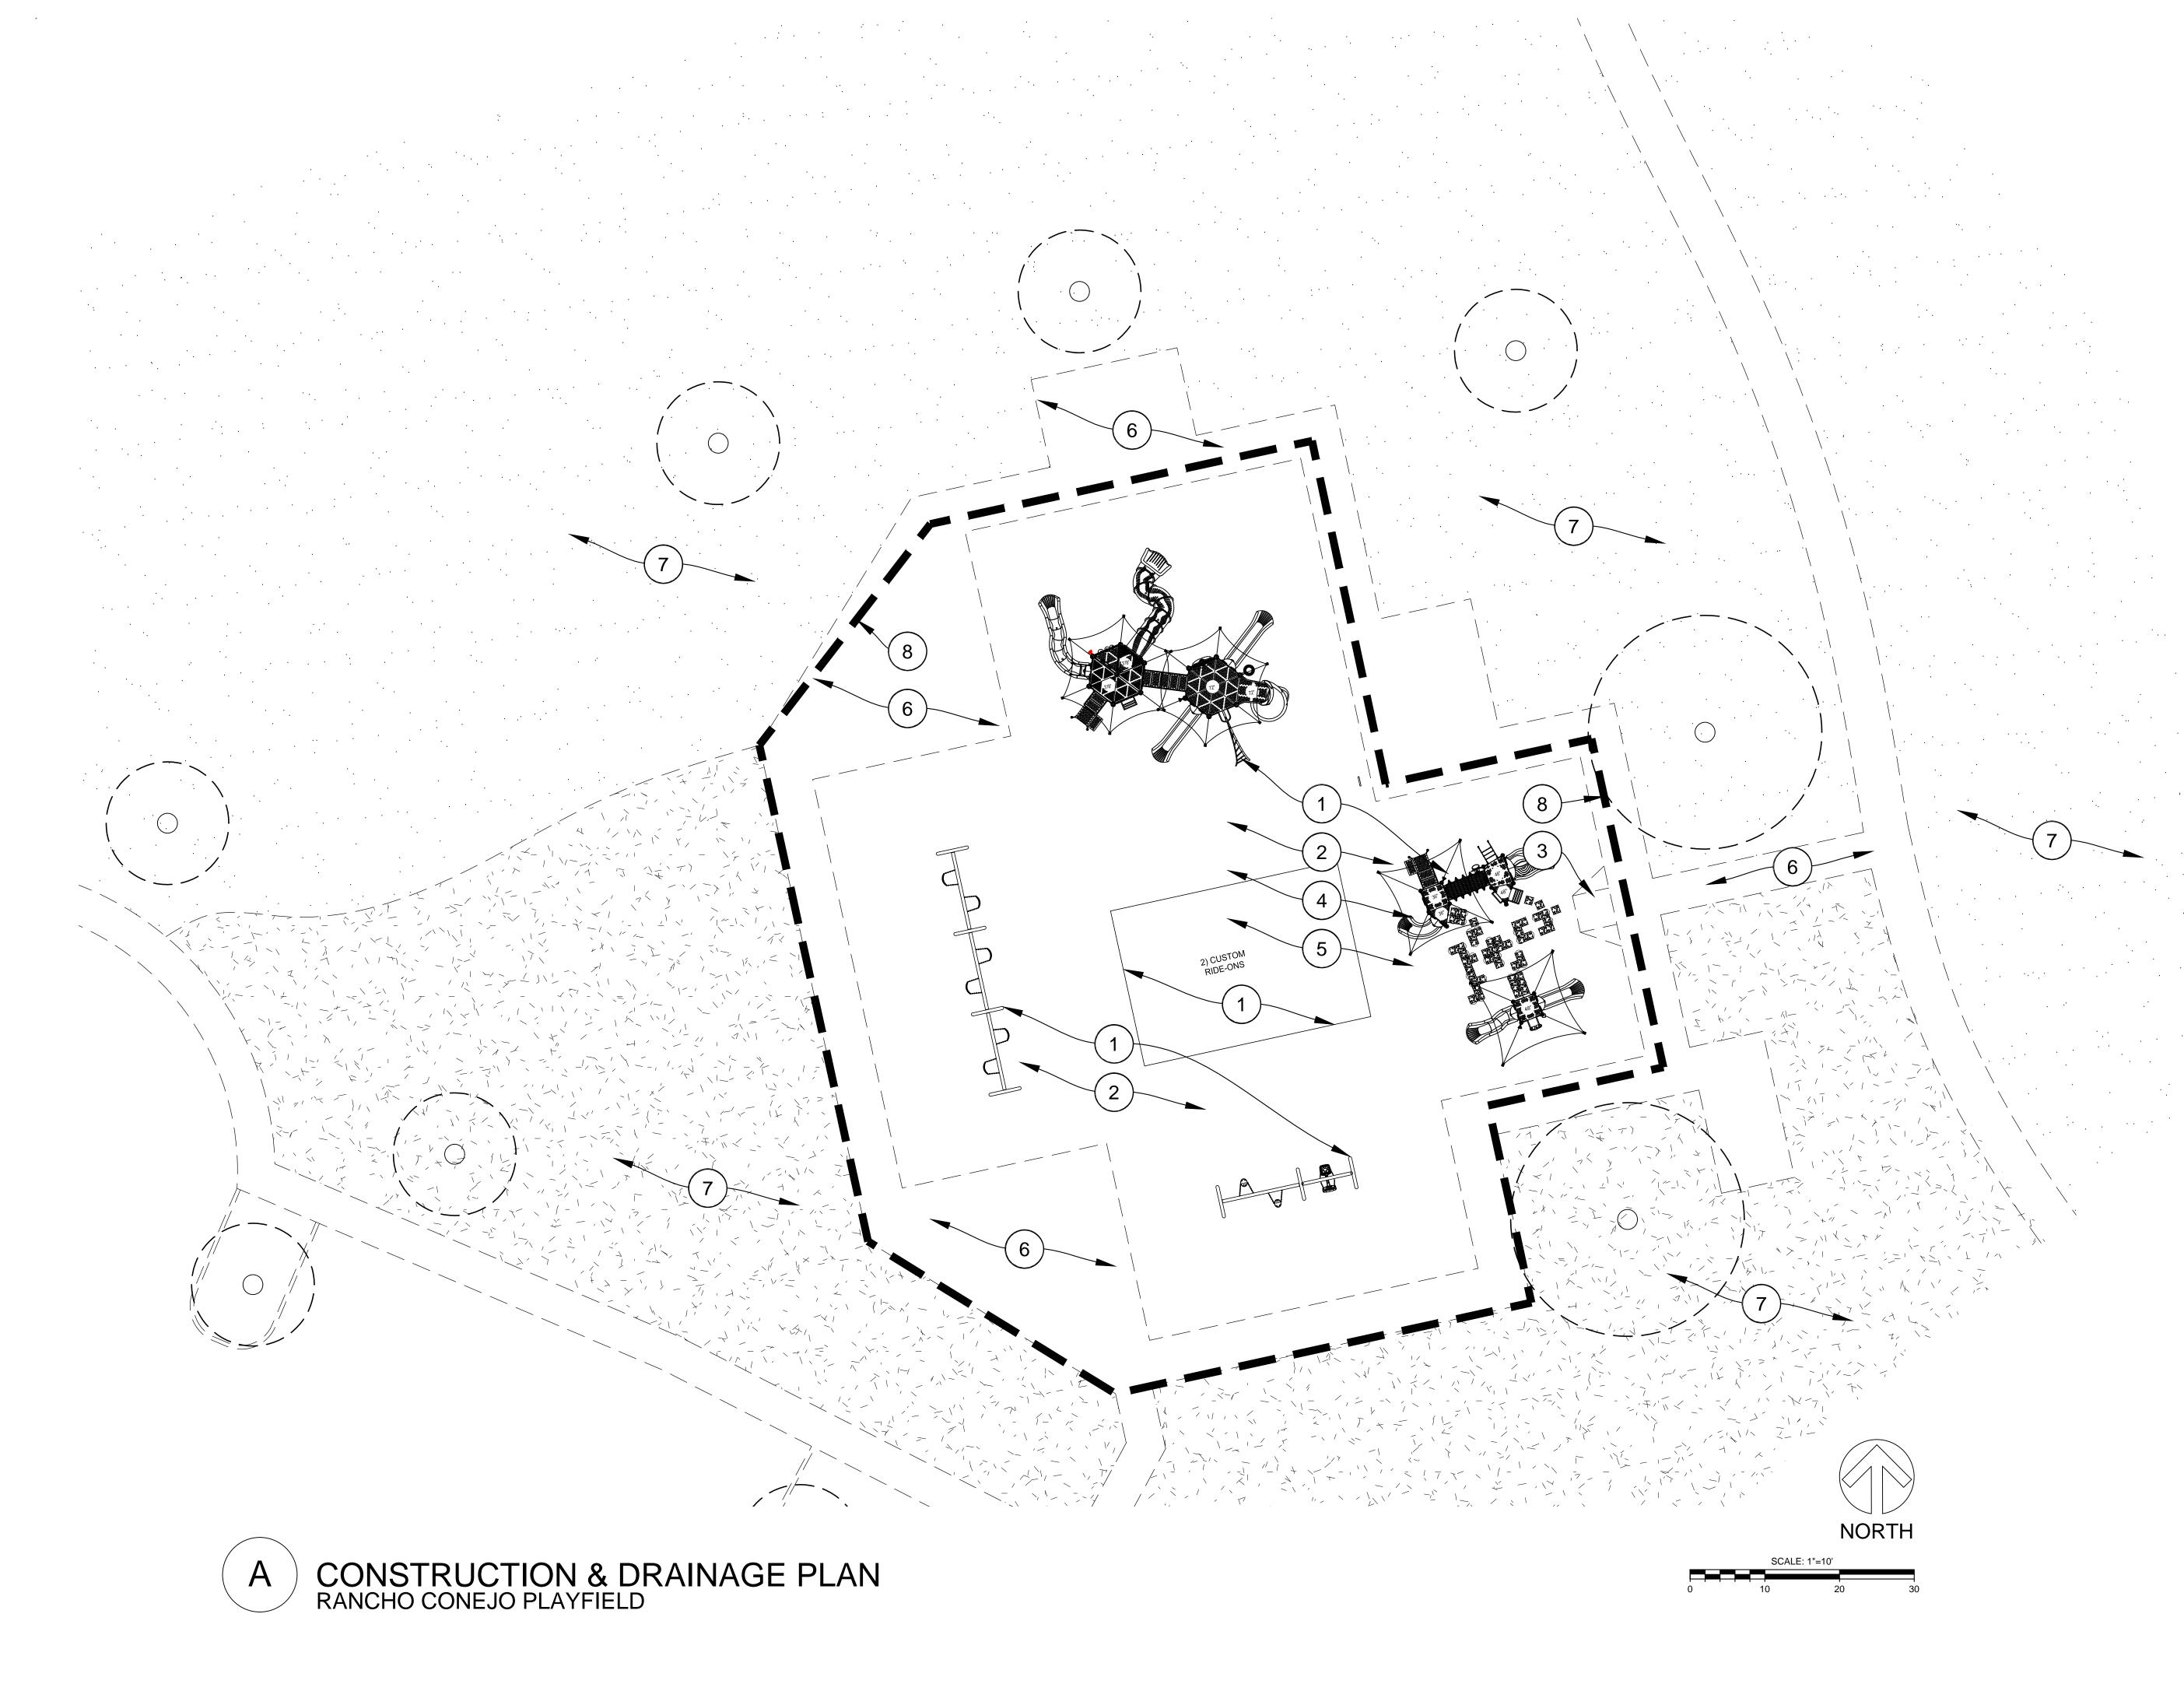
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EXISTING UNDERGROUND UTILITIES.

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CONSTRUCTION LEGEND

NO.	DESCRIPTION
1	PROVIDE AND INSTALL PLAY EQUIPMENT BY PLAYWORLD. INSTALLATION TO BE PERFORMED BY NPSI CERTIFIED INSTALLER WITH AT LEAST (5) PREVIOUS INSTALLATIONS. PLAY AREA MUST MEET REQUIREMENTS FOR ASTM F1487; PUB 325. REFER TO MANUFACTURER'S PLANS. DO NOT INSTALL BIBA GAME APPLICATION - EQUIPMENT TO BE RETURNED TO MANUFACTURER
2	PROVIDE AND INSTALL ENGINEERED WOOD FIBER (EWF) 14" DEEP. MUST CONFORM TO IPEMA CERTIFIED AND ASTM F1292 AND F2075. INSTALL PERMEABLE FILTER SEPARATION CLOTH MIRAFI 140NL GEOTEXTILE BELOW EWF.
3	EXISTING CONCRETE RAMP TO REMAIN: PROTECT IN PLACE.
4	PREPARE SUBGRADE SLOPING TO EXISTING DRAIN.
5	CLEAR AND TEST EXISTING DRAINAGE AT PLAY AREA. PROTECT IN PLACE EXISTING DRAIN INLETS AND PIPES. REPAIR AS NEEDED DUE TO DEMOLITION FOR PROPER FUNCTIONING PLAY AREA DRAIN SYSTEM.
6	EXISTING CONCRETE PAVING TO REMAIN: PROTECT IN PLACE.
7	EXISTING ADJACENT PLANTING, IRRIGATION LINES AND EQUIPMENT PROTECT IN PLACE.





O RECREATION AND PARK DISTRICT EST HILLCREST DRIVE SAND OAKS, CA. 91360


CONSTRUCTION PLAN

RANCHO CONEJO PLAYFIELD PLAYGROUND IMPROVEMENT 950 N. VENTU PARK ROAD THOUSAND OAKS, CA 91360

NO.	REVISIONS/I	ISSUE	DATE

ı	ISSUED FOR:	DATE	
ı	BID	MAY 20, 2019	
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ı	DRAWN / CHECKED		
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	1" = 10'-0"	RCP	
1	SHEET		

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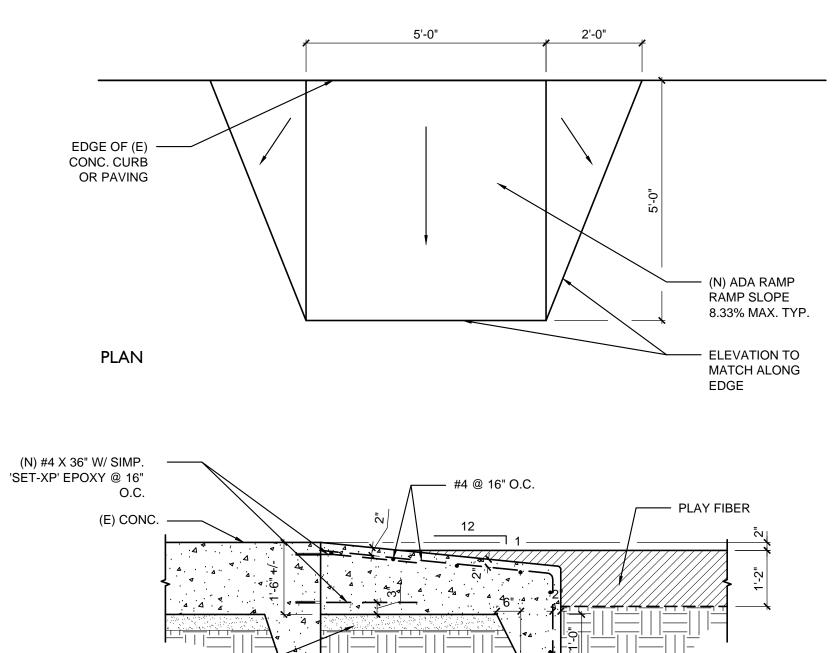


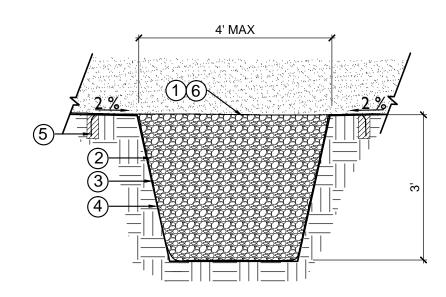
Α

DRAINAGE PIT AT PLAYGROUND

- 1. 14" DEEP ENGINEERED WOOD FIBER (EWF) IN PLAY AREA. INSTALL ACCORDING TO MANUFACTURER'S INSTRUCTIONS
- ② 3/4 -INCH CLEAN CRUSHED GRAVEL
- ③ GEOTEXTILE SEPARATION FABRIC, TENCATE MIIRAFI NL OR APPROVED EQUAL, TO ALLOW DRAINAGE, FILTRATION AND SEPARATION BETWEEN:
- ENGINEERED WOOD FIBER AND EARTH.
 PIT GRAVEL AND EARTH.
- ENGINEERED WOOD FIBER AND SUMP GRAVEL.
- (4) SUMP WALL OR UNDISTURBED SUBGRADE, NATIVE SOIL, SLOPE AT 1-1/2 TO 1, MAX.
- (5) GEOTEXTILE ANCHOR BURY END OF GEOTEXTILE MIN 8 INCHES INTO COMPACTED SOIL.
- 6 GEOTEXTILE SEPARATOR INSTALL ON SUBGRADE BELOW EWF. ANCHOR ACCORDING TO MANUFACTURER'S INSTRUCTIONS.


N.T.S.



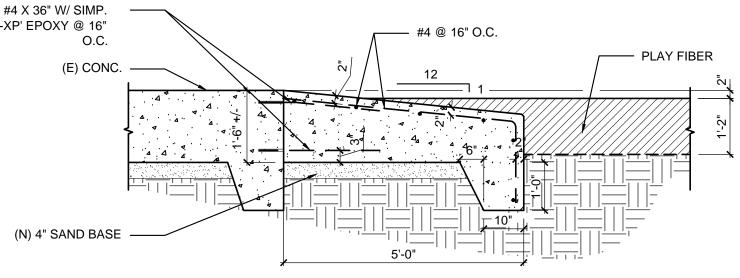

SECTION ADA CONCRETE RAMP AT PLAYGROUND В

SCALE: 1/2" = 1'-0"

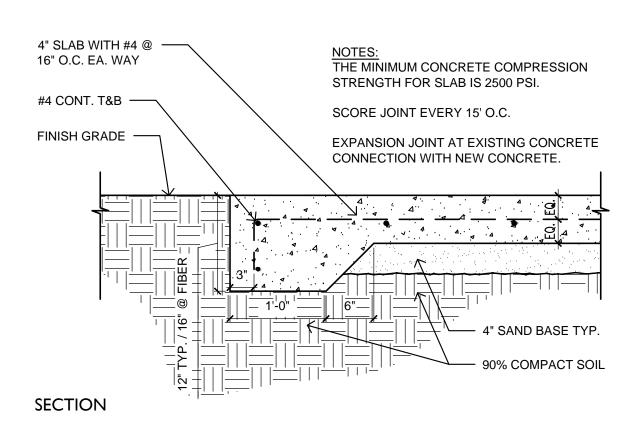





DISTRIC⁻ PARK ST HILLCREST DRIVE AND OAKS, CA. 91360

CONSTRUCTION **DETAILS**

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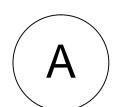
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CONSTRUCTION PLAN

SYMBOL LEGEND

SYMBOL	DESCRIPTION
***************************************	5' WIDE PERMEABLE ASPHALT PATHWAY TO BE LAID OUT IN THE FIELD WITH DISTRICT STAFF.


CONSTRUCTION LEGEND

NO.	DESCRIPTION
1	INSTALL PERMEABLE ASPHALT PATHWAY PER PLAN A AND DETAIL B THIS SHEET. PATHWAY TO BE LAID OUT IN THE FIELD PRIOR TO CONSTRUCTION. PATHWAY AREA TO BE CLEARED OF MULCH AND TURF PRIOR TO COMPACTION OF SUBGRADE. *NOTE: NO ADDITIONAL TURF TO BE REMOVED EXCEPT FOR CENTRAL PATHWAY.


EXISTING GROUNDCOVER TO REMAIN (TURF, MULCH AND D.G.)

BID ALTERNATE #I

INSTALL "SAND" COLORED PERMEABLE ASPHALT PATHWAY PER PLAN A AND DETAIL B THIS SHEET. PATHWAY TO BE LAID OUT IN THE FIELD PRIOR TO CONSTRUCTION. PATHWAY AREA TO BE CLEARED OF MULCH AND TURF PRIOR TO COMPACTION OF SUBGRADE. *NOTE: NO ADDITIONAL TURF TO BE REMOVED EXCEPT FOR CENTRAL PATHWAY.

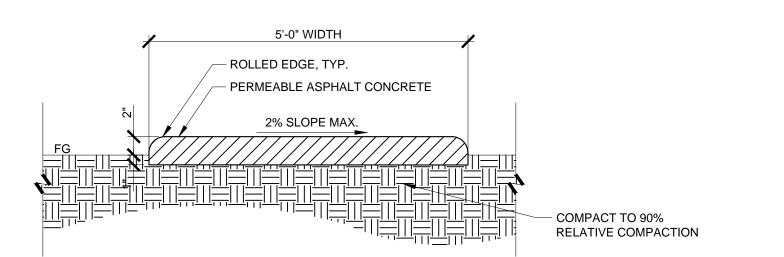

PERMEABLE ASPHALT CONCRETE SHALL BE ACCORDING TO LATEST EDITION GREENBOOK STANDARD SPECIFICATIONS FOR PUBLIC WORKS CONSTRUCTION.

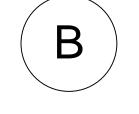

PERMEABLE ASPHALT PATHWAY DETAIL SCALE 1"=1'-0"

GENERAL DEMOLITION NOTES

- 1. PROTECT IN PLACE EXISTING TREES PER TREE PROTECTION NOTES THIS SHEET.
- 2. CONTRACTOR SHALL IMPLEMENT TEMPORARY PROJECT CONTROLS, INCLUDING PREPARATION AND MAINTENANCE OF BMPS AS REQUIRED. SEE TITLE SHEET.
- 3. CONTRACTOR IS RESPONSIBLE FOR REMOVAL OF ALL MATERIALS INDICATED ON PLANS.

7. NO OPEN TRENCH SHALL BE LEFT EXPOSED WITHOUT FLAGMEN OR SECURITY GUARD.

- 4. ANY HAZARDOUS MATERIALS SHALL BE DISPOSED OF BY CONTRACTOR PRIOR TO GENERAL DEMOLITION.
- 5. UTILITY SHUTOFF SHALL BE COORDINATED BY CONTRACTOR, THE CITY OF THOUSAND OAKS AND DISTRICT.
- 6. WORK SHALL BE PERFORMED IN ACCORDANCE WITH CAL-OSHA CONSTRUCTION SAFETY ORDERS, MOST RECENT EDITION.
- 8. NO OPEN EXCAVATION SUCH AS TRENCH OR PLANTING PIT GREATER THAN 4 INCHES DEEP WILL BE LEFT EXPOSED OR UNSECURED
- 9. PROTECT IN PLACE EXISTING IMPROVEMENTS INCLUDING WALLS, PAVING, FENCING, PLANTING, IRRIGATION EQUIPMENT, VALVES, AND VALVE BOXES.
- 10. CONTRACTOR TO ESTABLISH INGRESS & EGRESS, & CONSTRUCTION ACCESS ROUTES TO LIMIT SITE DISTURBANCE

TREE PROTECTION NOTES

THESE TREE SPECIFICATIONS SHALL BE FOLLOWED TO PROTECT ALL TREES WHOSE DRIPLINE IS ENCROACHED UPON EITHER DIRECTLY OR INDIRECTLY BY CONSTRUCTION.

- A. GENERAL REQUIREMENTS
- 1. NO EQUIPMENT IS TO BE PARKED UNDER A TREE, NOR ARE ANY MATERIALS TO BE STORED WITHIN THE TREE'S DRIPLINE OR LEANED AGAINST A TREE TRUNK.
- 2. DO NOT PILE OR COMPACT SOIL WITHIN A DRIPLINE.
- 3. DO NOT NAIL GRADE STAKES OR ANYTHING ELSE TO TREES.
- 4. DO NOT STRIP TOPSOIL. ANY VEGETATION TO BE REMOVED SHOULD BE REMOVED BY CUTTING AT GROUND LEVEL RATHER THAN PULLING OUT BY EQUIPMENT.
- 5. USE OF PNEUMATIC DRILLS IS NOT PERMISSIBLE; EXCAVATION AROUND ROOTS MUST BE PERFORMED BY HAND ONLY, NO POWER TOOLS. CUT ANY ROOTS CLEANLY WITHOUT FRAYED OR SPLIT ENDS, AND SOIL BACKFILLED IMMEDIATELY.
- 6. ALL LANDSCAPE AREAS ARE TO RECEIVE UNINTERRUPTED IRRIGATION DURING ALL CONSTRUCTION.
- B. TYPICAL WORK PROCEDURES
- 1. ALL WORK AROUND ANY EXISTING TREES SHALL FOLLOW THIS WORK PROCEDURES PROGRAM. THIS PROGRAM HAS BEEN DEVELOPED TO MINIMIZE IMPACTS TO EACH TREE AND PROTECT THEM FROM UNSCHEDULED DAMAGE
- 2. ALL WORK WITHIN A TREE'S ROOT ZONE SHALL BE AS DIRECTED BY DISTRICT STAFF.
- 3. THE EXTENT OF ALL WORK AFFECTING ANY OAKS SHALL BE STAKED BY FIELD SURVEY AND REVIEWED WITH THE DISTRICT STAFF PRIOR TO IRRIGATION INSTALLATION.
- 4. HAND DIG VERTICAL TRENCH AT THE FINAL CUT LINE TO FINAL GRADE AND CLEANLY CUT ANY ROOTS ENCOUNTERED AND SEAL WITH APPROVED TREE SEAL
- 5. NO FURTHER WORK WITHIN THE ROOT ZONE SHALL BE DONE BEYOND WHICH WAS APPROVED, WITHOUT OBTAINING WRITTEN APPROVAL FORM DISTRICT STAFF PRIOR TO PROCEEDING.
- C. DAMAGES
- 1. IF A TREE, DESIGNATED TO REMAIN, IS REMOVED OR CAUSED TO BE IRREVERSIBLY DAMAGED AS DETERMINED BY DISTRICT STAFF, CONTRACTOR SHALL INSTALL A REPLACEMENT TREE MATCHING SIZE, QUALITY, AND VARIETY USING AN INSTALLER DESIGNATED BY THE DISTRICT. IF AN ACCEPTABLE REPLACEMENT TREE IS NOT AVAILABLE, CONTRACTOR WILL PAY DAMAGES TO THE DISTRICT FOR THE DAMAGED TREE VALUE AS ASSESSED BY THE TREE VALUE FORMULA IN ISA GUIDE FOR ESTABLISHING VALUE OF TREES AND

CONSTRUCTION AND GRADING GENERAL NOTES

- 1. ALL WORK SHALL CONFORM TO ALL CITY, COUNTY AND OTHER GOVERNING AGENCIES' REGULATIONS FOR CONSTRUCTION, GRADING AND DRAINAGE. CONTRACTOR SHALL OBTAIN ALL NECESSARY PERMITS, INSPECTIONS AND APPROVALS REQUIRED FOR
- 2. FOR LOCATIONS OF EXISTING CONDITIONS, PROPERTY LINES, EASEMENTS, UTILITIES, ETC., REFER TO THE BOUNDARY AND TOPOGRAPHIC SURVEY. THE CONTRACTOR SHALL BE RESPONSIBLE FOR IDENTIFYING IN THE FIELD ALL PROPERTY LINES, EASEMENTS AND RESTRICTIONS IDENTIFIED ON THE PLANS.
- 3. THE CONTRACTOR SHALL BE RESPONSIBLE FOR THE ACCURATE LAYOUT OF THE PROJECT, FOR ESTABLISHING ALL REFERENCE POINTS, ELEVATIONS AND LINES SET FOR CONSTRUCTION, FOR CERTIFICATION OF FINISH GRADES AS SHOWN ON THE DRAWINGS, AND TO MATCH EXISTING SURFACES WHERE APPLICABLE. IF NEEDED, THE CONTRACTOR SHALL EMPLOY A REGISTERED CIVIL ENGINEER OR LICENSED LAND SURVEYOR IN ORDER TO ACCURATELY DETERMINE ALL HORIZONTAL AND VERTICAL DIMENSIONS.
- 4. CONTRACTOR SHALL VISIT THE SITE, VERIFY EXISTING CONDITIONS, BECOME FAMILIAR WITH EXISTING GRADES, SITE AND SOIL CONDITIONS.
- 5. THE CONTRACTOR SHALL NOTIFY THE DISTRICT OF ANY DISCREPANCIES BETWEEN THE ACTUAL SITE CONDITIONS AND THE PLANS PRIOR TO BEGINNING CONSTRUCTION.
- 6. WRITTEN DIMENSIONS SHALL PREVAIL OVER SCALED MEASUREMENTS ON THE PLANS AND DETAILS.
- 7. THE DISTRICT IS TO REVIEW AND APPROVE ALL LAYOUTS IN THE FIELD PRIOR TO THE START OF CONSTRUCTION.
- 8. VERIFY AND CLEARLY MARK THE LOCATION OF ALL UNDERGROUND UTILITIES AND SERVICES PRIOR TO ANY EXCAVATION. THE CONTRACTOR ASSUMES FULL RESPONSIBILITY FOR ALL DAMAGE CAUSED BY FAILURE TO DO SO.
- 9. DUST CONTROL AND EROSION & SILTATION PREVENTION SHALL BE IMPLEMENTED THROUGHOUT CONSTRUCTION AS REQUIRED BY THE GOVERNING AGENCIES, LOCAL CODES AND ORDINANCES.
- 10. CONTRACTOR SHALL KEEP THE SITE WATERED SUFFICIENTLY TO ELIMINATE DUST NUISANCE. SPECIMEN AND EXISTING TREES TO REMAIN SHALL BE WASHED DOWN WEEKLY TO HELP MAINTAIN THEIR HEALTH DURING CONSTRUCTION.
- 11. REPORT ANY CONDITIONS WHICH PREVENT PROPER EXECUTION OF THIS WORK TO THE DISTRICT.
- 12. THE CONTRACTOR SHALL BE RESPONSIBLE FOR PROTECTING FROM DAMAGE ALL STRUCTURES, UNDERGROUND UTILITIES AND ANY EXISTING PLANT MATERIAL IDENTIFIED TO REMAIN ON THE SITE.
- 13. NO BRANCHES, LIMBS OR ROOTS OF ANY PLANT MATERIAL ARE TO BE CUT OR PRUNED WITHOUT AUTHORIZATION AND DIRECTION
- 14. ALL PLANTING AREAS SHALL BE GRADED AT A MINIMUM OF 2% AWAY FROM STRUCTURES AND TOWARD APPROPRIATE DRAINAGE INLETS, UNLESS OTHERWISE NOTED ON PLANS. FINISH GRADES SHALL BE ONE (1) INCH BELOW ADJACENT PAVING IN LAWN AREAS, AND TWO (2) INCHES BELOW ADJACENT PAVING IN SHRUB/GROUND COVER AREAS.
- 15. NEW PAVING AREAS SHALL BE SET FLUSH TO EXISTING ADJACENT PAVING SURFACES. PAVING CROSS SLOPE SHALL BE MINIMUM OF 2%.
- 16. PAVING AREA DRAINAGE SHALL BE DIRECTED AWAY FROM BUILDINGS AND STRUCTURES AT A MINIMUM OF 2 % FOR 5 FEET OR AS INDICATED ON THE DRAWINGS. ALL SURFACE FLOW SHALL BE DIRECTED TOWARD AND FLOW FREELY INTO DRAINAGE INLETS.
- 17. REFER TO PLAYGROUND MANUFACTURERS PLANS AND SPECIFICATION FOR FALL AND SAFETY ZONE. VERIFY ALL COMPONENTS AND SAFETY ZONE CONFORM TO ASTM F1487-11 AND STANDARD CONSUMER SAFETY PERFORMANCE SPECIFICATIONS FOR PLAYGROUND EQUIPMENT FOR PUBLIC USE CAN/CSA-Z614-07 - CHILDREN'S PLAYSPACES AND EQUIPMENT PRIOR TO PURCHASE AND INSTALLATION.
- 18. FINE GRADED SUBGRADE DRAINAGE SHALL BE 2% MINIMUM. FINE GRADING AROUND PLAY STRUCTURES SHALL DRAIN AWAY FROM FOOTINGS, TO THE DISTRICT'S SATISFACTION.
- 19. REPAIR AND REPLACE ANY EXISTING IMPROVEMENTS DAMAGED DURING CONSTRUCTION TO PRE-CONSTRUCTION CONDITION TO DISTRICT'S SATISFACTION. THIS INCLUDES ANY TURF AREAS ADJACENT TO WORK AND THROUGHOUT THE PROPERTY.





CONSTRUCTION PLAN

RE	REVISIONS				
NO.	REVISIONS	/ISSUE	DATE		
ISS	SUED FOR:	DATE			
	BID	MAY 13, 2019			
	DRAWN / CHECKED				

PROJECT NO. REFER TO SHEET

SHEET

Know what's **below**.

Call 811 before you dig.

DIG ALERT








KIMBER PARK

OPTION #2.5

dave bang associates, inc.

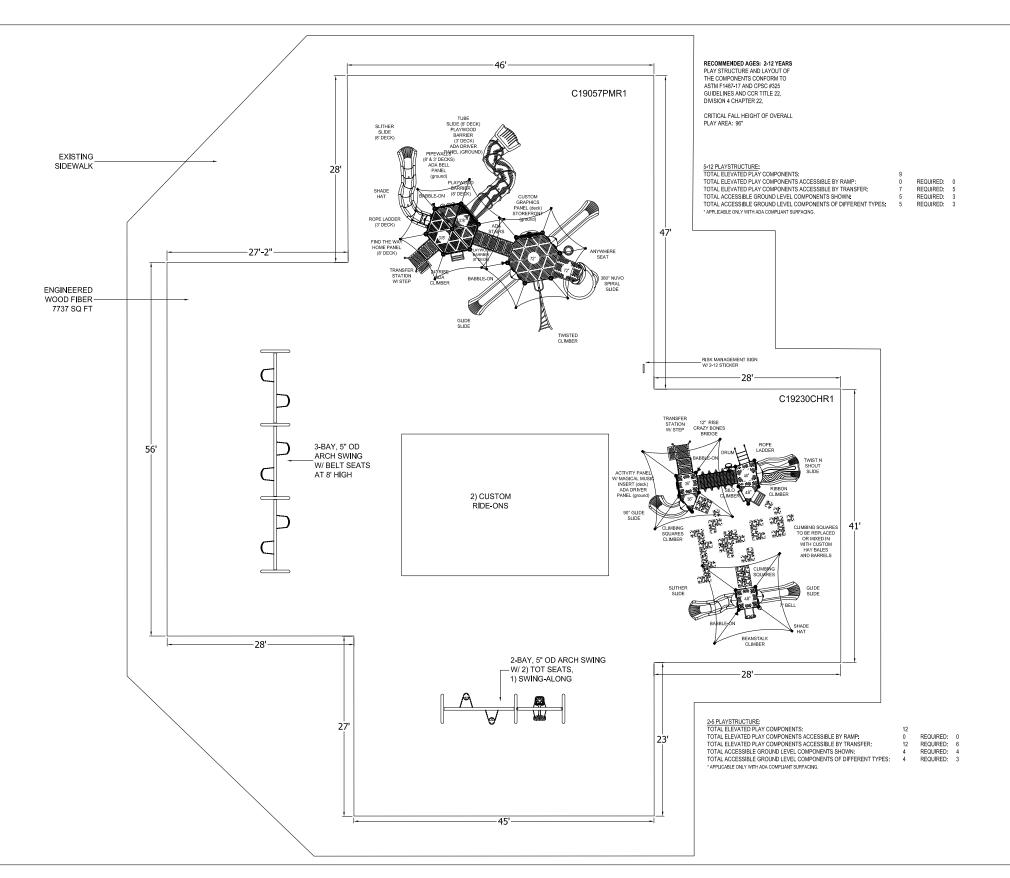

2019 SITE PLAN

SITE PLAN

PROJECT NO:

C18185SPR2 19

DATE.

11-MAY-19 SCALE:

NTS

DRAWN BY:

Marilyn Allen

> PLAYWORLD®

RANCHO CONEJO PLAYFIELD

THOUSAND OAKS, CA

dave bang associates, inc.